Town of East Hartford



ADDENDUM No. 03

Replacement of Rooftop HVAC Units

Community Cultural Center 50 Chapman Place

Bid No. 19-09

Issued February 19, 2019

The following summarizes revisions to the Bid Documents included in Addendum N^2 . 03 for the Replacement of Rooftop HVAC Units (Bid No. 19-09).

- This Addendum clarifies conflicting language between Addendum No. 1 (3rd bullet point) and Addendum No. 2 (the added note for *Building Management System*). The language of Addendum No. 1 is correct; the lists provided in Section 230900 are NOT restricted list. Unnamed/unlisted manufacturers may be proposed for use on the project
- Add Alternate No. 1 is added to the project for the complete replacement of <u>all</u> existing VAV boxes in the Community Cultural Center. Replacement VAV boxes shall utilize BACnet controls and all associated components shall be BACnet compatible. Wireless controls can be proposed in lieu of wired systems. The *Bid Proposal Sheet* is revised to reflect this addition.
- Mechanical drawings from the 1996 building renovation are included with this Addendum for bidder information. These drawings show the proposed location of the HVAC system components. The actual location of HVAC system components may vary from these drawings. The drawings include:
 - Lower Level Mechanical Plan
 - Main Level Mechanical Plan
 - Upper Level Mechanical Plan
 - Schedules & Details
 - Temperature Controls

The following documents & drawings are modified by Addendum N^{0} . 03:

Revised Bid Documents

• Replace the *Bid Proposal Sheet* (Page 18 of 437) with 2 revised pages (Page 18 and 18.1 of 437) included with the Addendum.

Revised Drawings

• <u>Drawing M-1:</u> Revise the Note for "Building Management System" (created in Addendum No. 2) to read: 1. Contractor shall provide a complete new BMS as required in Specification Section 230900. Contractor shall provide a new complete working system that is based on one of the manufactures listed in the specifications. Contractor shall provide a complete working system that is open to future modifications and additions. The remaining control systems that have not been upgraded shall be connected to the new BMS.

End of Addendum No. 03

Company Name:

TOWN OF EAST HARTFORD BID PROPOSAL SHEET REPLACEMENT OF ROOFTOP HVAC UNITS Bid No. 19-09

Bidder will complete the Work in accordance with the Contract Documents for the following, all-inclusive price:

Y G	
Lump Sum Base	(words)
Bid Price	
	3
	(numerals)

Add Alternate No. 1 The Work of Add Alternate No. 1, includes the replacement of all existing VAV boxes with BACnet controls [approximately 59 units] and replacement of associated thermostats, control writing & wiring back to the front end [all components must be BACnet compatible] in the Community Cultural Center. Wireless controls can be proposed in lieu of wired systems. Bidder will complete Add Alternate No. 1 for the following, all-inclusive price:

Lump Sum	
Bid Price Add Alternate	(words)
No. 1	*
	\$
	(numerals)

- A. The undersigned understands that there may be changes, omissions, or modification in the work, and that appropriate adjustments will be made to the Contract price in accordance with the Contract Documents. The undersigned understands that the Owner reserves the right to accept or reject any or all bids, and to waive all formalities, any irregularities, and accept the Bid deemed to be in the Owner's best interest.
- B. Bid prices shall not include any sales, excise or other taxes for which the Owner is not liable.
- C. Town of East Hartford is the awarding authority. The Bidder agrees to hold the above pricing for sixty (60) days, unless extended by mutual consent.

Company Name:

- D. The Bidder hereby agrees to commence Work under this Contract within ten (10) days of written Notice to Proceed from the Town, and to complete the Work of all base bid items within **no later than FRIDAY**, **AUGUST 30**, **2019**, which shall be the required Date of Completion. The Bidder further agrees to pay as **liquidated damages**, **the sum of ONE THOUSAND DOLLARS** (\$1,000.00) for each consecutive calendar day beyond the date of completion. Liquidated damages are not intended as a penalty but rather shall be construed as a best estimate of damages which the Town will suffer due to Bidder's refusal, failure or neglect to perform pursuant to his Bid and Contract Documents.
- E. The Bid security in the sum of: 5% OF TOTAL BID is to become the property of the Town in the event the above forms are not executed within the time set forth above, as liquidated damages, and not as a penalty for the delay and additional expense to the Town caused thereby.

ADDENDUM NO. 3

THIS DRAWING IS ISSUED FOR BID #19-09 REPLACEMENT OF ROOFTOP HVAC UNITS,

COMMUNITY CULTURAL CENTER FOR BIDDER INFORMATION ONLY.

GENERAL NOTES:

- 1) ALL DUCTWORK SHALL BE MOUNTED AS TIGHT TO THE STRUCTURE AS POSSIBLE.
- 2) CONTRACTOR SHALL PROVIDE AT ALL PENETRATIONS OF CORRIGOR WALLS BY THE ROUND SUPPLY DUCT WHERE MASONRY REMAINS, A 20" X20" SQUARE SHEET METAL COLLAR FITTED AND SEALED TO THE ROUND DUCT.
- 3) CONTRACTOR SHALL PROVIDE 1-1/2"x1-1/2" COLLAR ON CORRIDOR SIDE OF WALL ON SQUARE RETURN OUCTS.
 4) PROVIDE VOLUME OAMPERS AT ALL BRANCHES AND TAKE-OFFS.
- 4) PROVIDE VOLUME OAMPERS AT ALL BRANCHES AND TAKE-OFFS.
 5) CONTRACTOR TO PROVIDE 10'-0' LINEAR FEET OF OUCTWORK OFF THE DISCHARGE OF THE VAV DAMPERS, LEFT LAYING ON THE FLOOR ADJACENT TO THE OAMPER. SEE VAV OAMPER SCHEDULE FOR SIZE OF OUCTWORK TO BE PROVIDED WITH EACH OAMPER.

VIOHALOAL

Legnos and Cramer, Inc.

Consulting Engineers
Mechanical & Electrical

Tel.(203)246-8875,Fax(203)525-2544

103 Hawthorn Street Hartford, Ct. 06105-3598

e 1-31-96tle 1/8"=1'-0"

drawn DAS checked RHR project no. 95-23

.95-23\MECH\M-1 1-26-96 12:31

LOWER LEVEL PLAN - MECHANICAL


1/8"=1"

ECUH-2

--- MOUNT HIGH

ON WALL

LEAVE THERMOSTAT HANGING IN CEILING WITH 25 FT OF WIRE.

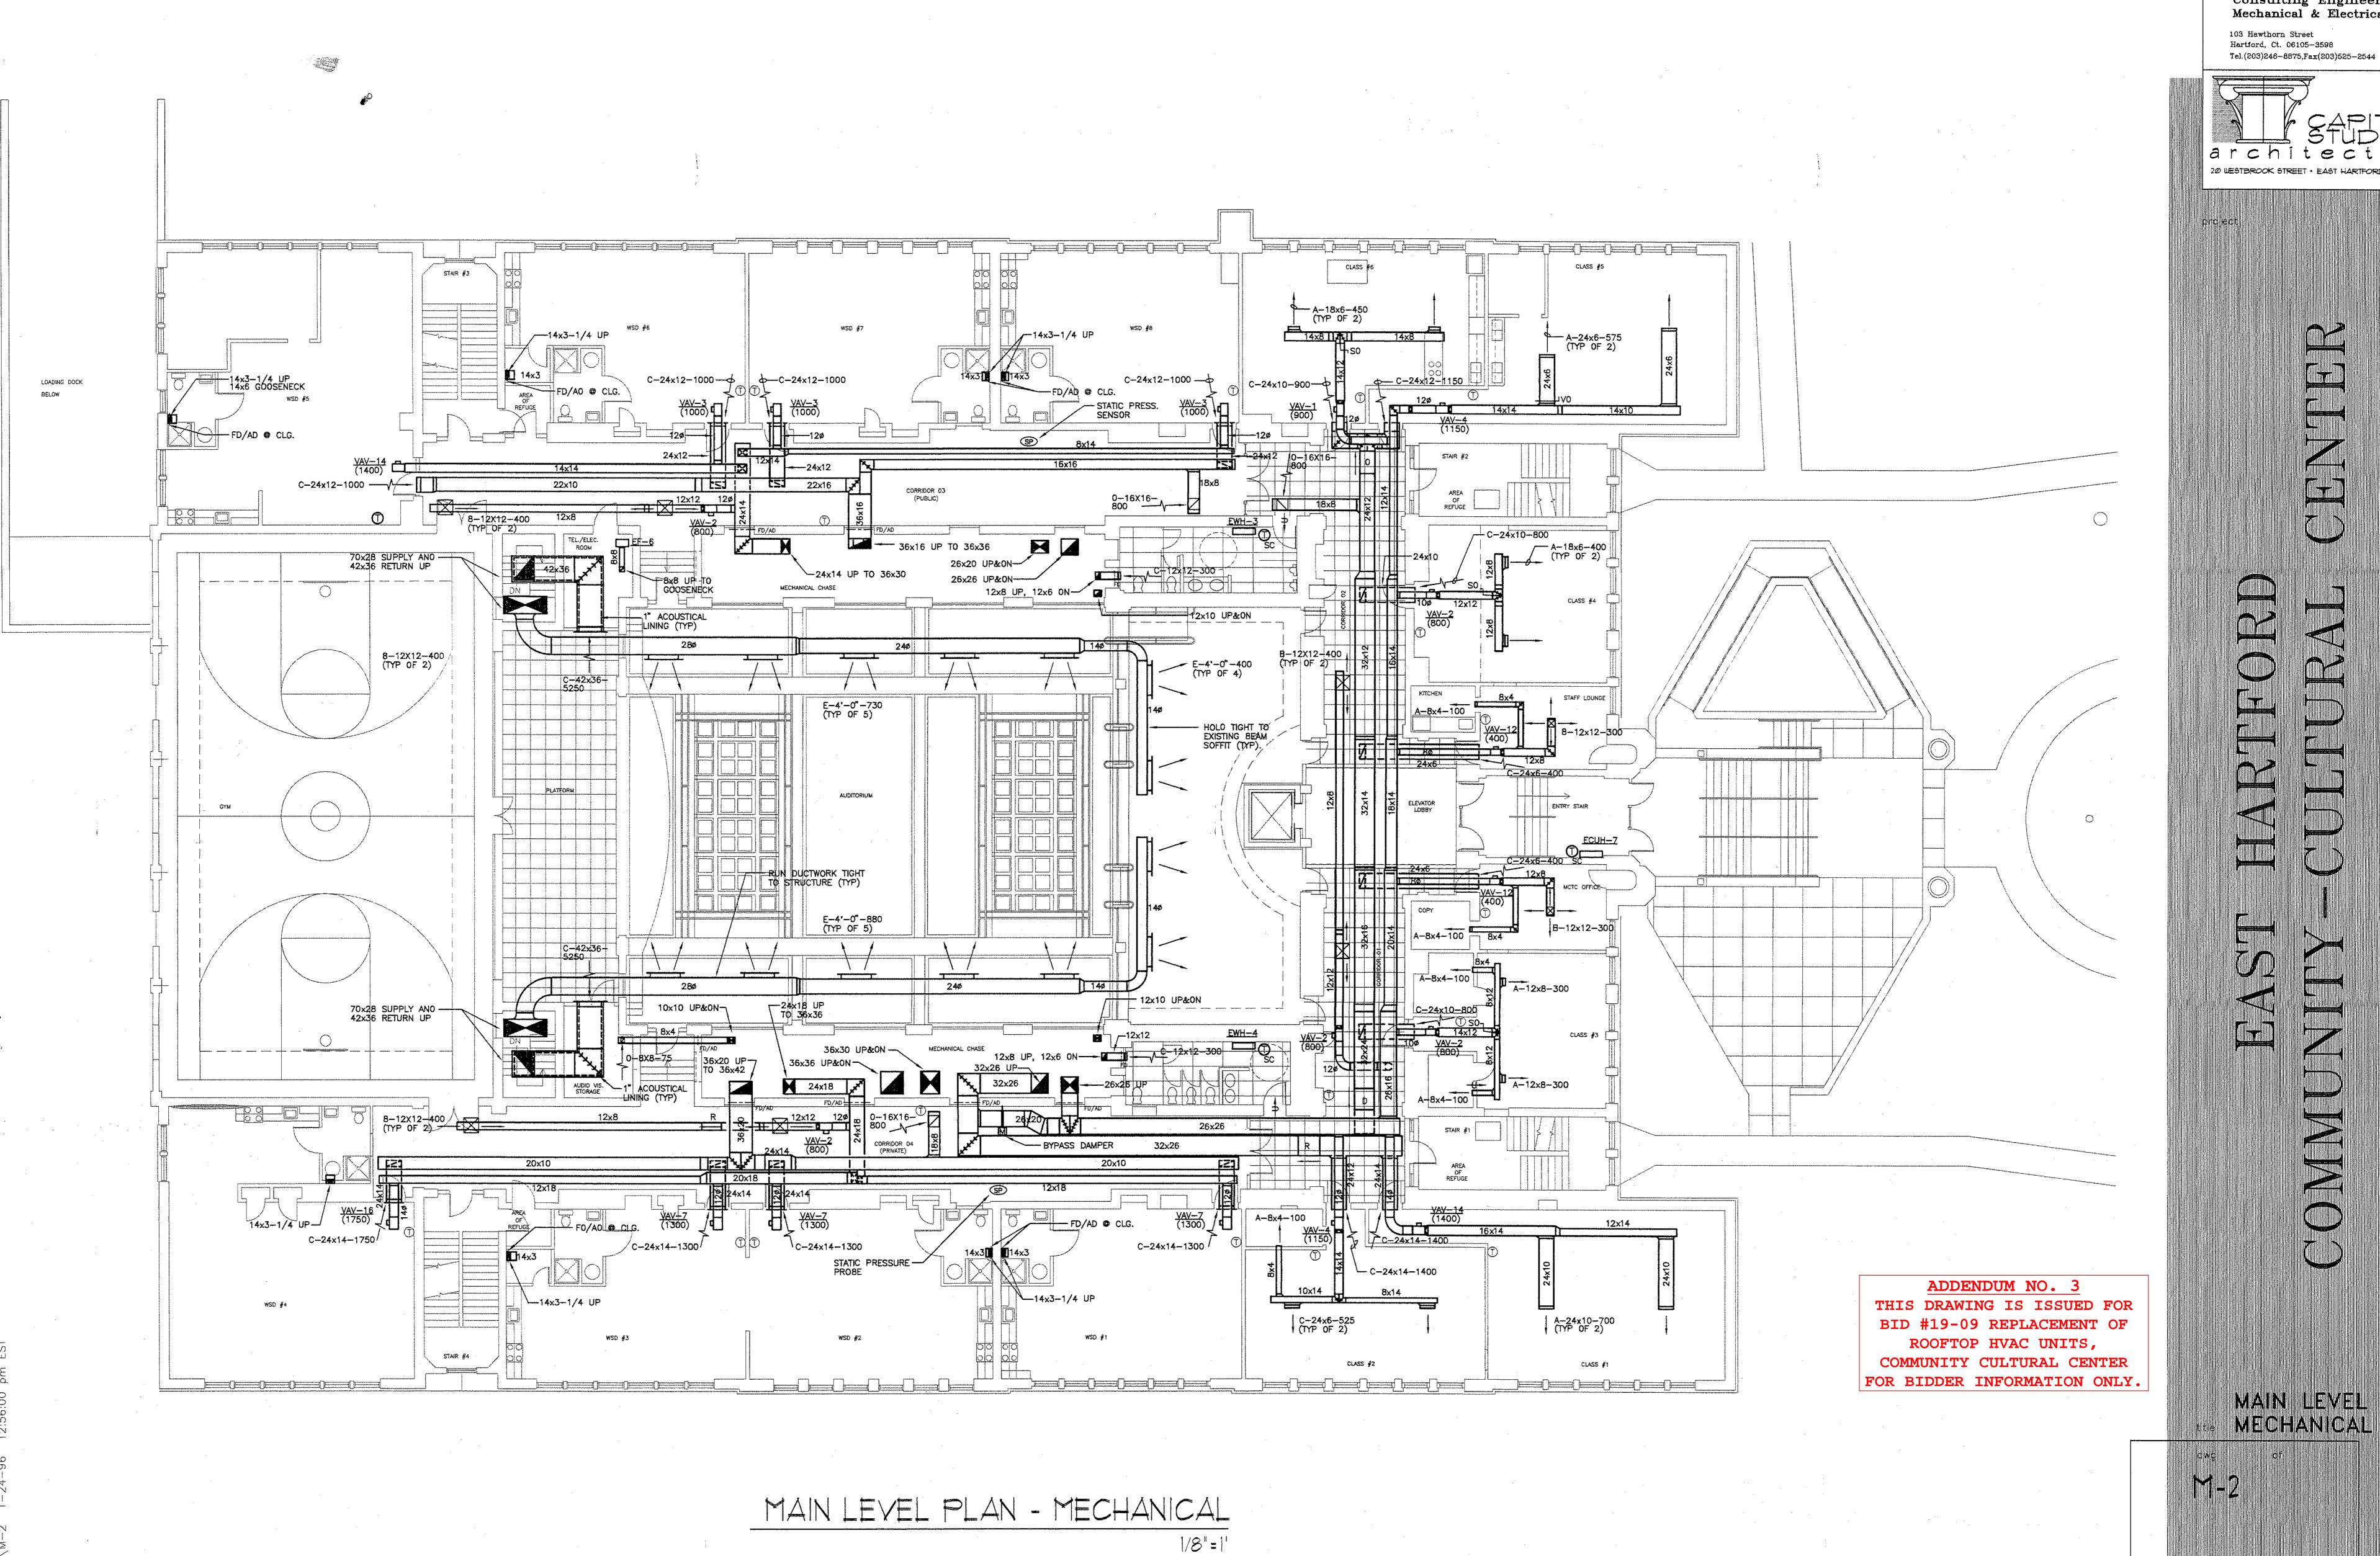

Legnos and Cramer, Inc. Consulting Engineers Mechanical & Electrical

103 Hawthorn Street Hartford, Ct. 06105-3598 Tel.(203)246-8875,Fax(203)525-2544

1-31-96

1/8"=1'-0" project no.

Legnos and Cramer, Inc. Consulting Engineers Mechanical & Electrical 103 Hawthorn Street Hartford, Ct. 06105-3598

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ADDENDUM NO. 3 THIS DRAWING IS ISSUED FOR BID #19-09 REPLACEMENT OF ROOFTOP HVAC UNITS, COMMUNITY CULTURAL CENTER

FOR BIDDER INFORMATION ONLY.

UPPER LEVEL PLAN - MECHANICAL


1/8"=1

Y


1/8"=1'-0" project no.

UPPEN LEVEL
MEDERANICAL

PRIMARY FIRE DAMPER DETAIL TYPE "B"

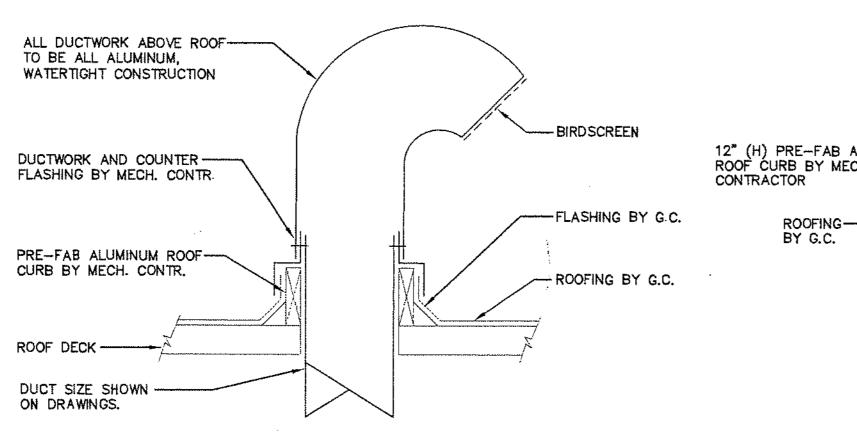

GOOSENECK DETAIL

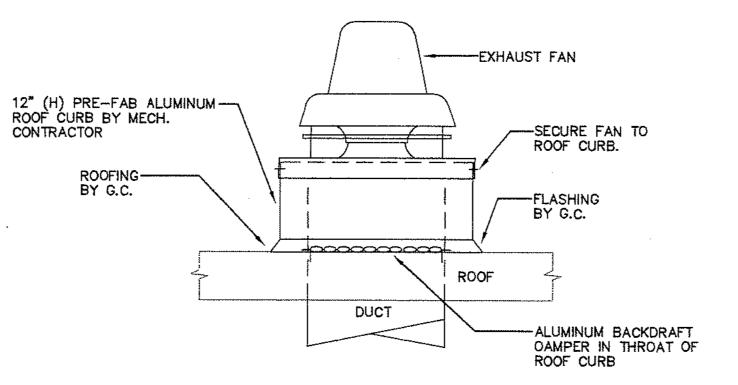


ROOF MOUNTED FAN DETAIL

"LOREN COOK" AS STANDARD EXHAUST FAN SCHEDULE (PENN VENTILATOR, GREENHECK EQUALS) TAG FAN TYPE MODEL No. MOTOR HP VOLTAGE REMARKS (IN. W.G.) CEILING IN-LINE GC-720 500 0.25 SEE NOTE #1 115-1-60 300W CENTRIFUGAL ROOF MOUNTED EF-2 135C2B 1175 0.25 SEE NOTE #2 120C2B 450 0.25 SEE NOTE #2 B00 115-1-60 ROOF MOUNTED CENTRIFUGAL ROOF MOUNTE 120C2B 575 0.25 B20 SEE NOTE #2 115-1-60 CEILING IN-LINE EF-5 GC-720 500 0.25 115-1-60 SEE NOTE #3 300W CEILING IN-LINE EF-6 GC-320 150 0.125 1365 SEE NOTE #1 77W CEILING IN-LINE GC-320 SEE NOTE #1 EF-7 0.125 150 77W 115-1-60

- 1) PROVIDE WITH SOLID STATE SPEED CONTROLLER AND DISCONNECT MOUNTED AT FAN HOUSING.
- 2) PROVIDE WITH 12"(H) PREFAB ALUMINUM ROOFCURB AND INTEGRAL DISCONNECT.

3) PROVIDE WITH SOLID STATE SPEED CONTROLLER, DISCONNECT MOUNTED AT FAN HOUSING, AND WALL CAP.

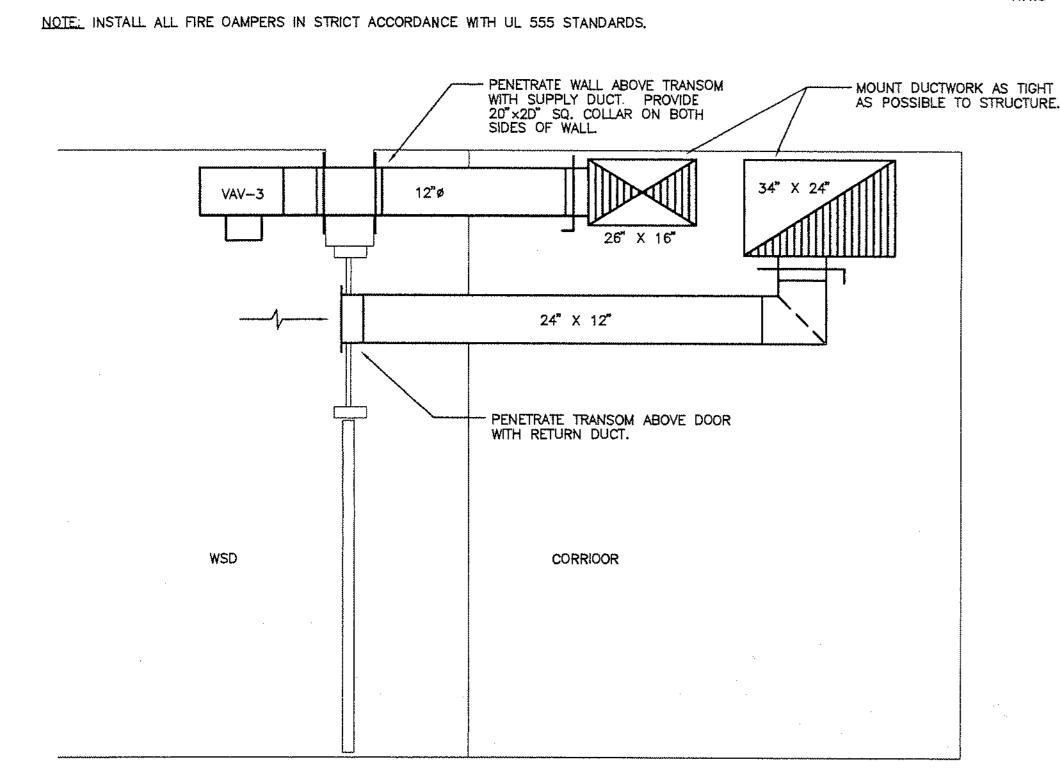

	DI	FFUSERS &	REGISTERS	3 "TUTTLE	& BAILEY" AS STD.
TAG	MODEL No.	DESCRIPTION	CONSTRUCTION	FINISH	REMARKS
Α	A5 4 7	SIDEWALL SUPPLY	EXTRUDEO ALUM.	PER ARCHITECT	DOUBLE DEFLECTION, OBD
В	AMV	CEILING SUPPLY	EXTRUDED ALUM.	PER ARCHITECT	OBD
С	A77D	SIDEWALL RETURN	EXTRUDED ALUM.	PER ARCHITECT	42' DEFLECTION, OBD
D	CR507	CEILING RETURN	EXTRUDED ALUM.	PER ARCHITECT	1/2"x1/2"x1" CORE, OBD
Е	4300	LINEAR BAR REG.	EXTRUDED ALUM.	PER ARCHITECT	6" WIDE, 15' DEFLECTION, OBD
F	VJR-2448	ROUND CLG. SUPPLY	STEEL	PER ARCHITECT	OB0

VAV	BOX SCHEDU	 *	NE" AS NDARD
TAG	MODEL No.	CFM	SIZE
VAV-1	VADA-12-CHGR	900	12"
VAV-2	VADA-10-CHGR	800	10"
VAV-3	VADA-12-CHGR	1000	12"
VAV-4	VA0A-12-CHGR	: 1150	12"
VAV-5	VADA-14-CHGR	1850	14"
VAV-6	VADA-08-CHGR	500	8"
VAV-7	VA0A-12-CHGR	1300	12"
VAV-8	VADA-06-CHGR	250	6"
VA V-9	VADA-06-CHGR	200	6"
VAV-10	VADA-10-CHGR	650	10"
VAV11	VADA-06-CHGR	300	6"
VAV-12	VADA-06-CHGR	400	6"
VAV-13	VADA-12-CHGR	950	12"
VAV-14	VADA-14-CHGR	1400	14"
VAV-15	VADA-14-CHGR	1500	14"
VAV-16	VADA-14-CHGR	1750	14"

	ELECTR	IC HE	AT SCI	HEDUL	E "BERK	(O" AS S	TANDARD
TAG	MODEL No.	WATTS	VOLTAGE	PH.	BTU/HR	СҒМ	REMARKS
EWH-1	FRC-1527	1500	277	1	5,120	_	SEE NOTE #1
EWH-2	FRC-1527	1500	277	1	5,120	<u>-</u>	SEE NOTE #1
EWH-3	FRC-1527	1500	277	1	5,120		SEE NOTE #1
EWH-4	FRC-1527	1500	277	1	5,120		SEE NOTE #1
EWH-5	FRC-1527	1500	277	4	5,120		SEE NOTE #1
EWH-6	FRC-1527	1500	277	Yesser	5,120		SEE NOTE #1
ECUH-1	CUH4-0448-1	4000	480	1	13,648	500	SEE NOTE #2
ECUH-2	CUH4-0448-1	4000	480	1	13,648	500	SEE NOTE #2
ECUH-3	CUH4-0448-1	4000	480	1	13,648	500	SEE NOTE #2
ECUH-4	CUH3-0227-1	2000	277	1	6,B24	250	SEE NOTE #2
ECUH-5	CUH4-0448-1	4000	4B0	1	13,648	500	SEE NOTE #2
ECUH-6	CUH3-0227-1	2000	277	1	6,824	250	SEE NOTE #2
ECUH-7	CUH3-0227-1	2000	277	1	6,B24	250	SEE NOTE #2
EUH-1	HUHAA-748	7500	480	. 3	25,600	650	SEE NOTE #3
EUH-2	HUHAA-748	7500	480	3	25,600	650	SEE NOTE #3
EUH-3	HUHAA-748	7500	4B0	3	25,600	650	SEE NOTE #3
EUH-4	HUHAA-748	7500	4B0	3	25,600	650	SEE NOTE #3
EUH-5	HUHAA-748	7500	480	3	25,600	650	SEE NOTE #3
EUH-6	HUHAA-548	5000	4B0	3	17,000	350	SEE NOTE #3

ROOFTOP UNIT SCHEDULE "TRANE" AS STANDARD

NO. VOLT PH.

460

460

460

460

460

COND. FAN MOTOR

460

3 | 3 | 460 | 3 | 4/1.1 | 460 | 3 | B0/67 | 57.5/55.7 | 451.B | 308.2 | B00 |

No./HP VOLT

4/1.1

4/1.1

- PROVIDE WITH BUILT-IN TAMPER-PROOF THERMOSTAT, THERMAL CUTOUT, FAN DELAY, DISCONNECT SWITCH, AND SURFACE MOUNTING FRAME.
- 2) PROVIDE WITH BUILT-IN TWO-STAGE THERMOSTAT AND CIRCUIT BREAKERS, AND ADAPTER FRAME FOR SURFACE MOUNTING.

3)	PROVIDE WITH A	UTOMATIC	FAN	DELAY,	THERMAL	CUTOUT,	POWER	DISCONNECT	SWITCH,	24	VOLT	CONTROL,	ANO
	MOUNTING BRAC	KET.										•	

DX COIL DATA

80/67 55.B/55.1 537.8

80/67 56.9/56.1 541.2

80/67 57.8/55.3 192.1

80/67 57.8/55.3 192.1

80/67 57.3/54.9

TYPICAL SECTION SCALE: 1/2"=1'-D"	1 M-4
THREADED ROD TO STRUCTURE ABOVE.	ABLE ABLE
OETAIL 2"x2"x1/B" ANGLE IRON	EQUIPMENT
ELEV. VIEW	THREADED ROD (TYP. OF 4) PLAN VIEW

EQUIPMENT SEISMIC RESTRAINT DETAIL #1

NOTE: 1. SEISMIC RESTRAINT FOR OUCTWORK IS SIMILAR

		S	SEISMIC E	BRACING	SCHEDUL	E		
PIPE SIZE (INCHES)	"ELCEN" (OR EOUAL) HANGER TYPE	BOLTS TO 'L' (2)	VERTICAL ANGLE (3)	DIAGONAL ANGLE	LOGITUDINAL OIAGONAL ANGLE (4)	TOP CONNECTION OF DIAGONAL & LOGITUDINAL '' S (1)	ROD SIZE (INCHES)	MAXIMUM LENGTH FOR ROOS
2 1/2	CLEVIS TYPE	3/B* ø	2 x 2 x 16GA	2 x 2 x 16GA	2-1/2x2-1/2x16GA	type ji	1/2" ø	25"
3	DD DO	3/B* ¢	2 x 2 x 16GA	2 x 2 x 16GA	2-1/2x2-1/2x16GA	TYPE II	1/2* ¢	25*
4	DO DO	3/B* ø	2 x 2 x 16GA	2 x 2 x 16GA	2-1/2x2-1/2x16GA	TYPE IV	5/B" ø	31*
5	00 D0	1/2" #	2 x 2 x 16GA	2 x 2 x 16GA	2-1/2x2-1/2x16GA	TYPE IV	5/B* ¢	31"
6	00 D0	1/2" #	2-1/2x2-1/2x16GA	2-1/2x2-1/2x16GA	2-1/2x2-1/2x16GA	TYPE V	3/4" ø	37*

'L' DENOTES ANGLE

METAL' L'S & NUT

- 1) SEE DETAILS ABOVE FOR TYPICAL CONNECTION TO STRUCTURAL (3) "VERTICAL ANGLE" IN THE SCHOULE IS REQUIRED IN ADDITION TO HANGER Supporting Members. ROD ONLY WHEN "MAXIMUM LENGTH FOR RODS" IS EXCEEDED. (2) PLACE STANDARD CUT WASHERS BETWEEN SHEET (4) SEE GENERAL NOTE 1 THIS SHEET FOR LONGITUDINAL DIAGONAL BRACE
 - GENERAL NOTES
- 1. PIPING SHALL BE TRANSVERSLY BRACED AT 40 FOOT INTERVALS AND 6. ALL RECTANGULAR OUCTWORK 6 SQ. FT. DR LARGER IN CRDSS-SECTIONAL AT TURNS OF MORE THAN 4 FEET. LONGITUDINAL BRACING AT 80 FOOT
- 2. PIPE RISERS THROUGH CORED OPENINGS REQUIRE NO FURTHER SEISMIC BRACING. (CORE DIAMETER TO BE A MAXIMUM OF 2"
- LARGER THAN PIPE O.D.) 3. ALL PIPING 2-1/2" OR LARGER SHALL BE SEISMICALLY BRACED. 4. ALL PIPING 1-1/4" OR LARGER IN BOILER AND MECHANICAL ROOMS SHALL
- AREA, AND ROUND OUCTWORK 28" OR LARGER IN DIAMETER SHALL BE SEISMICALLY BRACED. 7. ALL PIPING SUSPENOED BY INDIVIDUAL HANGERS 12" INCHES OR LESS IN LENGTH
- FROM THE TOP OF THE PIPE TO THE BOTTOM OF THE SUPPORT FOR THE HANGER SHALL NOT REQUIRE SEISMIC RESTRAINT.
 - B. ALL DUCTS SUSPENDED BY HANGERS 12" INCHES OR LESS IN LENGTH FROM THE TOP OF THE DUCT TO THE BOTTOM OF THE SUPPORT FOR THE HANGER SHALL NOT REQUIRE SEISMIC RESTRAINT.
- BE SEISMICALLY BRACED. 5. ALL GAS PIPING 1" OR LARGER SHALL BE SEISMICALLY BRACED. SEE PLUMBING DWGS

RTU-5 YCD600A4

RTU-8 YCD210B4

YCD210B4

YCD210B4

1) RATINGS BASED ON 95" AMBIENT.

MODEL No.

2) ALL FAN MOTORS SHALL BE HIGH EFFICIENCY.

15,650

5,250

5,250

5,000

0.8

0.5

0.5

3) ALL UNITS SHALL BE PROVIDED WITH 12"(H) PREFAB ALUMINUM ROOFCURBS. ECONOMIZER OPERATION WITH POWEREO EXHAUST AND COMPARATIVE ENTHALPY CONTROL.

5.0

10.0 1

3.0

460

RTU-4 YCD480A4 12,700 1.0 456 10.0 460 3 2/1.0 460

523

560

560

551

4) ALL UNITS SHALL BE PROVIDED WITH 2" THICK FARR 30/30 FILTERS. CONTRACTOR TO PROVIDE TWO ADDITIONAL FILTER CHANGES, ONE PRIOR TO AIR BALANCING, AND ONE PRIOR TO TURNING THE SYSTEM OVER TO THE OWNER.

2/1.0

2/1.0

1/0.75

460

460

ADDENDUM NO. 3 THIS DRAWING IS ISSUED FOR BID #19-09 REPLACEMENT OF ROOFTOP HVAC UNITS, COMMUNITY CULTURAL CENTER FOR BIDDER INFORMATION ONLY.

HEATING DATA

628

2B4

628

203

203

203

B00

B00

250


250

250

389.8

126.2

124.1

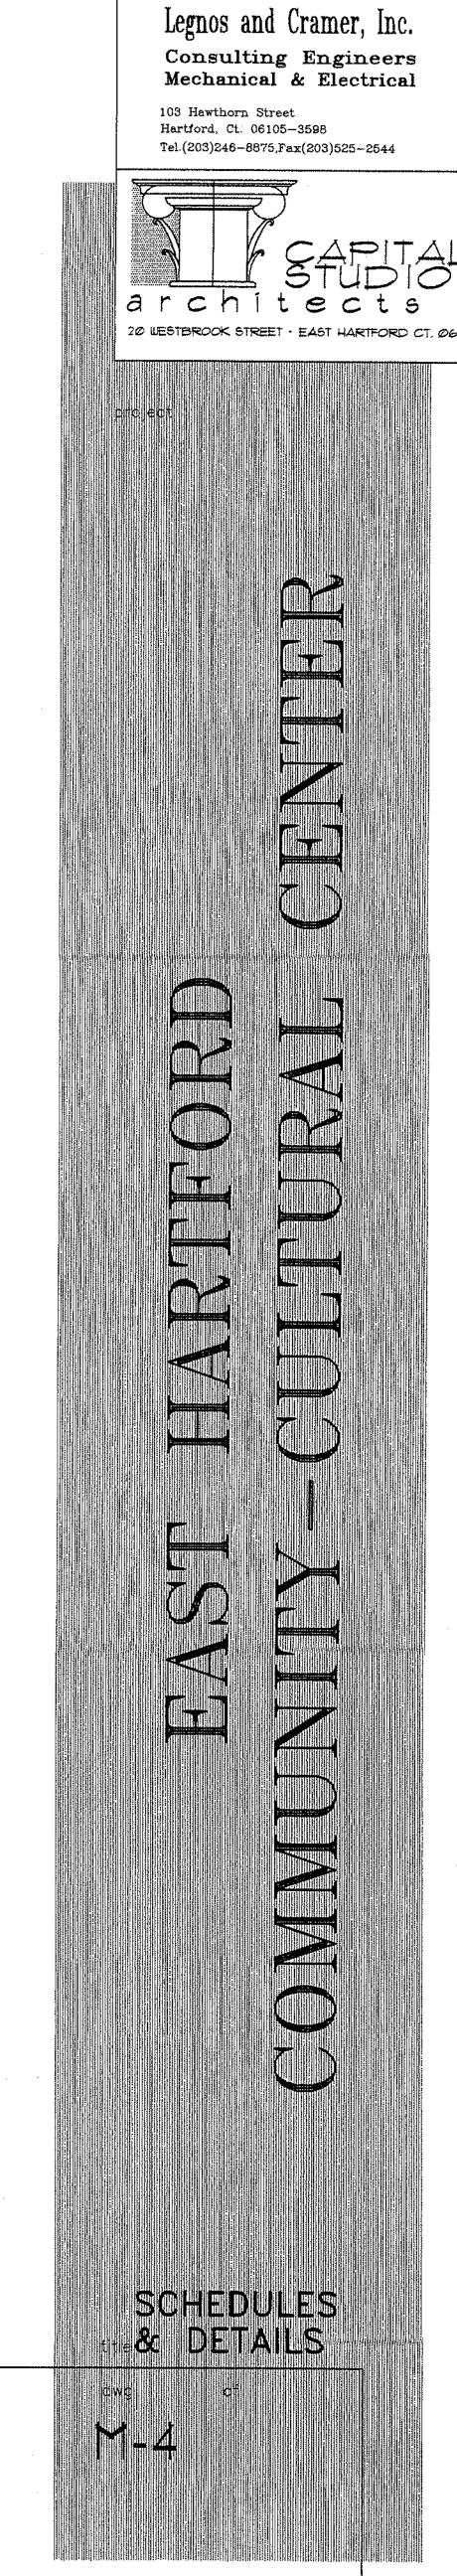

60 106.5 25

60 111.0 25

60 98.5

60 111.0


60 112.9

scale drawn RHR checked 95-23 project no.

date

AS NOTED

1-31-96

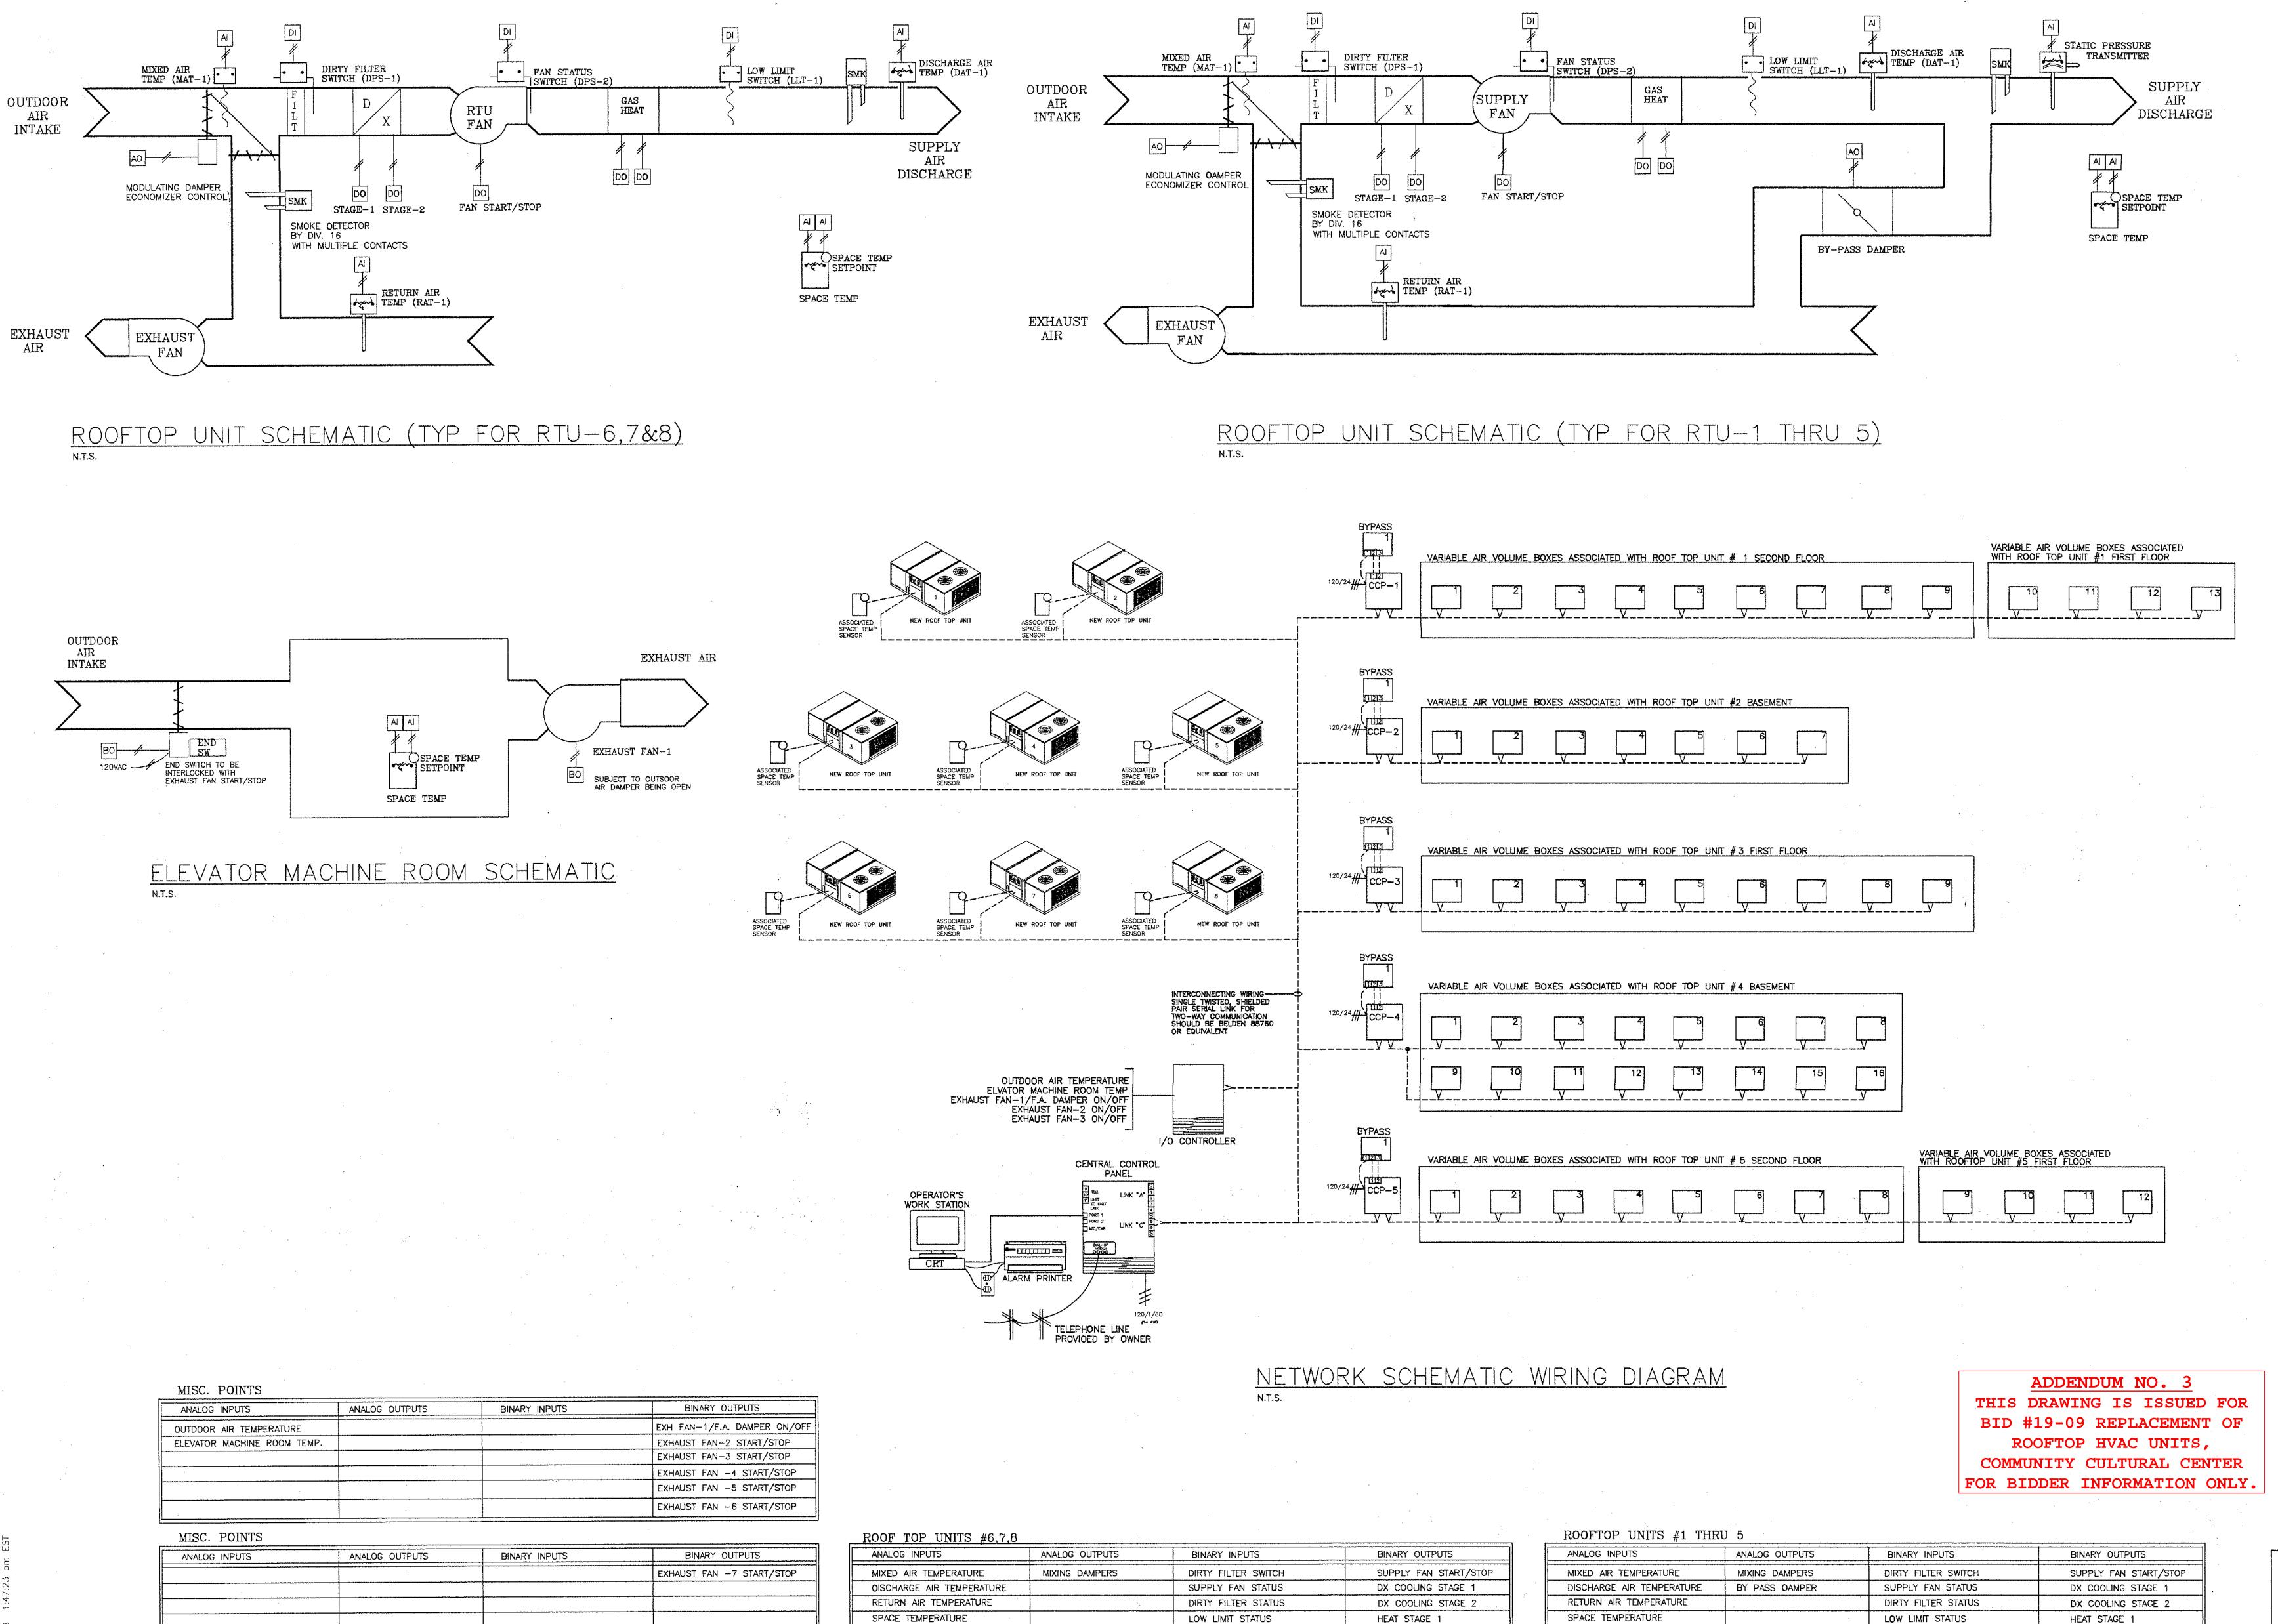

SPACE TEMPERATURE SETPOINT

Legnos and Cramer, Inc. Consulting Engineers Mechanical & Electrical 103 Hawthorn Street Hartford, Ct. 06105-3598 Tel.(203)246-8875,Fax(203)525-2544 20 WESTBROOK STREET . EAST HARTFORD CT. 06108 projecti TEXPERATURE ::.OXIXOLA 01-31-96 date AS NOTED scale DAS drawn RHR checked

95-23

project no.

I/O POINT LIST

SMOKE DETECTOR STATUS

HEAT STAGE 2

SPACE TEMPERATURE SETPOINT

DUCT STATIC PRESSURE

HEAT STAGE 2

SMOKE DETECTOR STATUS