



TOWN OF EAST HARTFORD, CONNECTICUT SITE PLAN AND SEDIMENT AND EROSION **CONTROL PLAN APPROVAL FOR** REPAVING OF OBB-1 & OBB-2 PARKING LOTS MAP LOT # 20-45


LOCATION: 400 MAIN STREET EAST HARTFORD, CT 06118

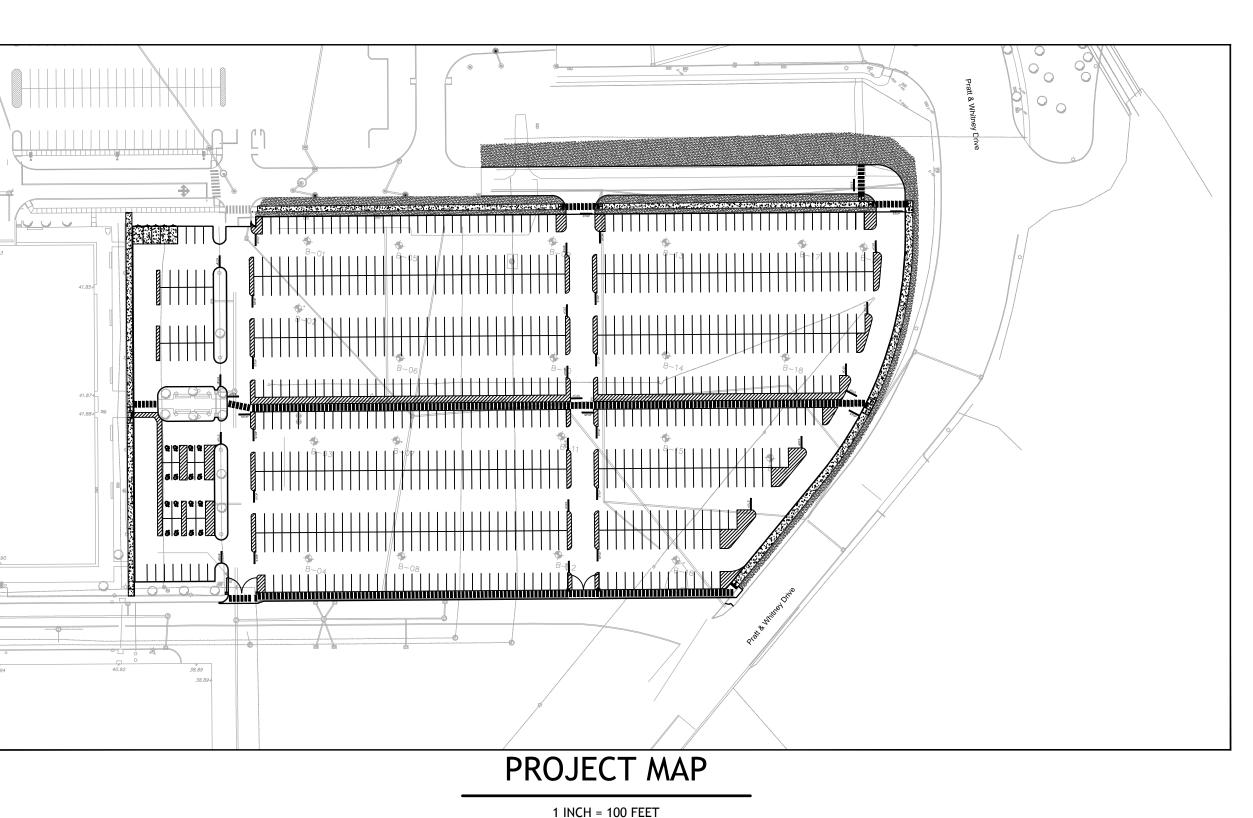

PREPARED FOR: PRATT AND WHITNEY 400 MAIN STREET EAST HARTFORD, CT 06118

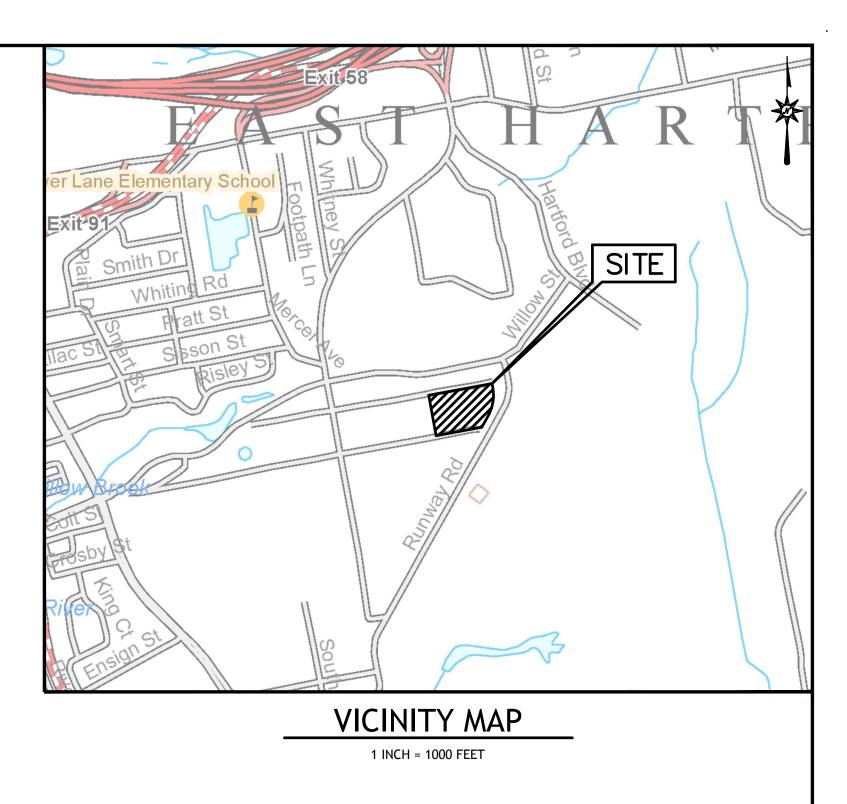

DRAWING LIS	ST ST
EX-1	TITLE SHEET LIMITED TOPOGRAPHIC SURVEY
DM-1	DEMOLITION PLAN
SP-1	SITE PLAN
GD-1	GRADING AND DRAINAGE PLAN
EC-1	SEDIMENT AND EROSION CONTROL PLAN
SE-1	SITE LIGHTING ELECTRICAL PLAN - NORTH
SE-2	SITE LIGHTING ELECTRICAL PLAN - SOUTH
SE-3	SITE LIGHTING POWER RISER AND CONTROLS
SE-4	SITE LIGHTING ELECTRICAL DETAILS
SE-5	SITE LIGHTING ELECTRICAL DETAILS
SE-6	SITE LIGHTING ELECTRICAL DETAILS
DN-1	SITE DETAILS
DN-2	SITE DETAILS
DN-3	SITE DETAILS
PRATT AND WHITNEY 400 MAIN STREET EAST HARTFORD, CT 06118	
DATES	
ISSUE DATE: FE REVISION:	EBRUARY 21, 2017
	PREPARED BY: FREEMAN
	COMPANIES
LA	AND DEVELOPMENT ENGINEERING DESIGN CONSTRUCTION SERVICES DBE DAS MBE GNMSDC CERTIFIED
	CIVIL GEOTECHNICAL SURVEY ENVIRONMENTAL
	FREEMAN COMPANIES, LLC 36 JOHN STREET HARTFORD, CT 06103 TEL: 860-251-9550 FAX: 860-986-7161 WWW.FREEMANCOS.COM

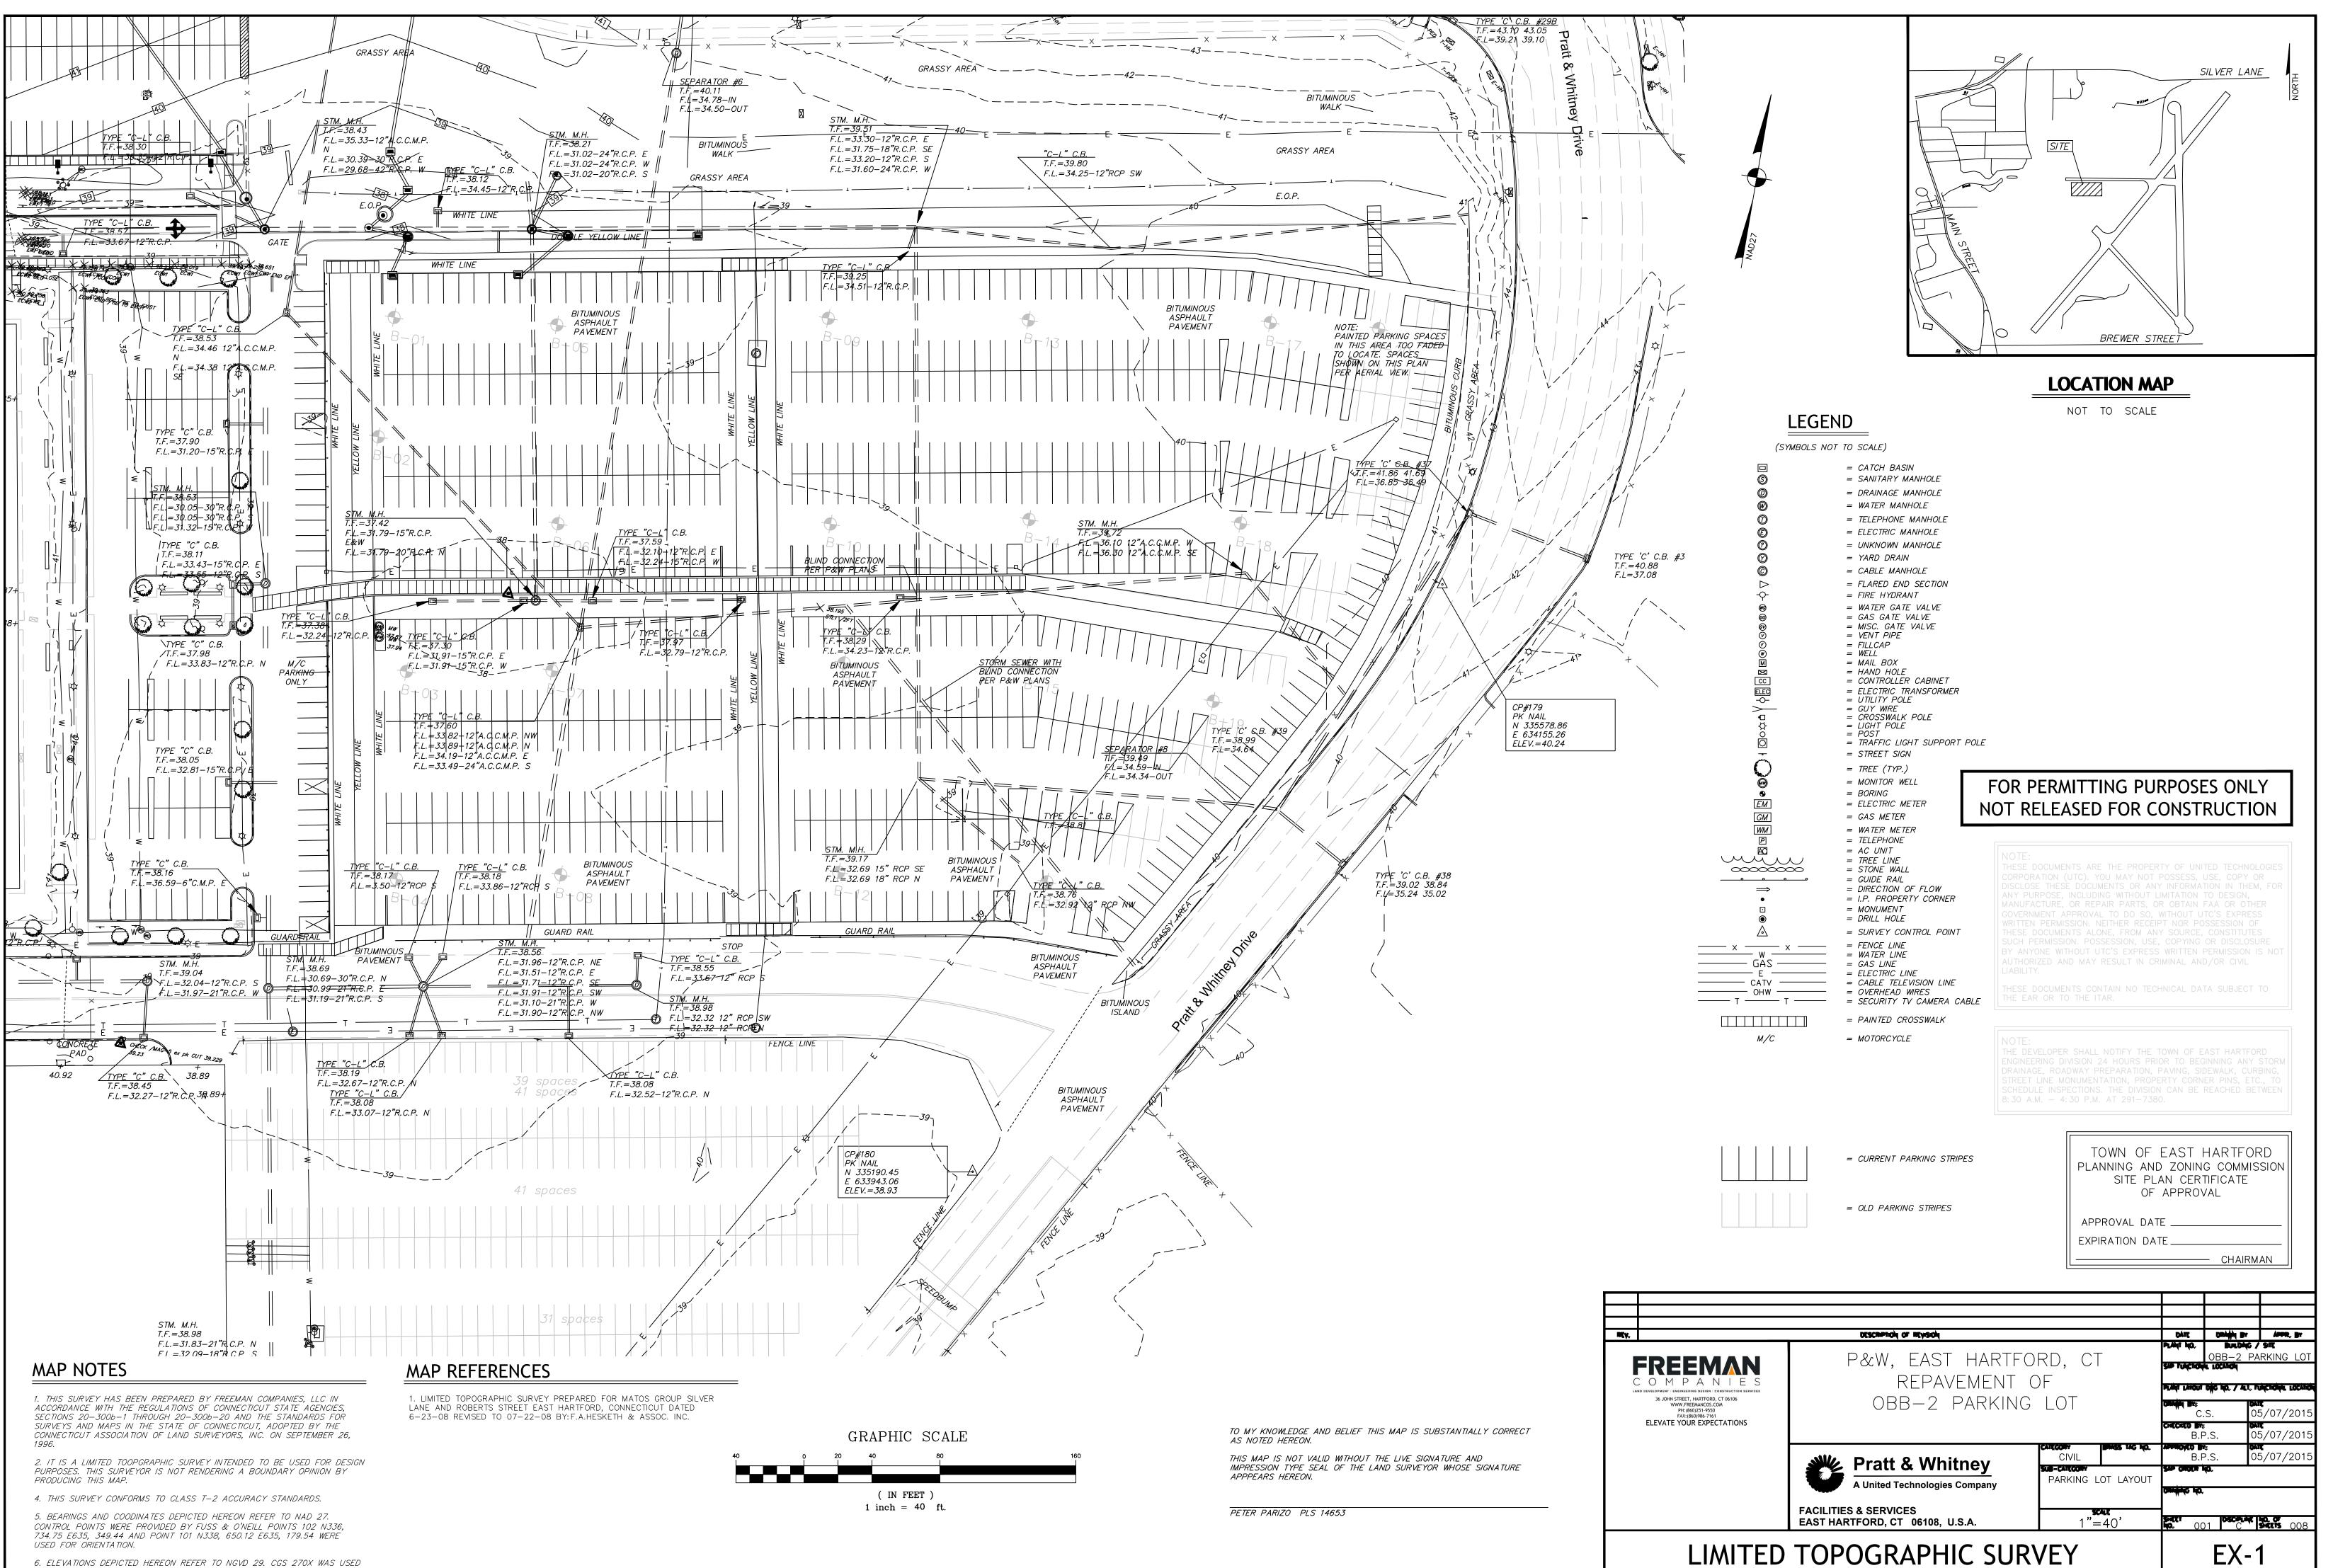


FOR REFERENCE. ELEVATION = 46.18.

DEMOLITION NOTES

- 1. SEDIMENT AND EROSION CONTROLS AS SHOWN ON THE SEDIMENT AND EROSION CONTROL PLAN SHALL BE INSTALLED BY THE CONTRACTOR PRIOR TO START OF DEMOLITION AND CLEARING AND GRUBBING OPERATIONS.
- 2. REMOVE AND DISPOSE OF ANY CONCRETE/PAVEMENT DEBRIS AND RUBBISH REQUIRING REMOVAL FROM THE WORK AREA IN AN APPROVED OFF-SITE LANDFILL, BY AN APPROVED HAULER. HAULER SHALL COMPLY WITH ALL LOCAL, STATE AND FEDERAL REGULATORY REQUIREMENTS.
- 3. THE CONTRACTOR SHALL SECURE ALL PERMITS FOR HIS DEMOLITION WORK AND DISPOSAL OF HIS DEMOLITION MATERIAL TO BE REMOVED FROM THE SITE. THE CONTRACTOR SHALL POST BONDS AND PAY PERMIT FEES AS REQUIRED. BUILDING DEMOLITION CONTRACTOR SHALL BE RESPONSIBLE FOR PERMITS AND DISPOSAL OF ALL BUILDING DEMOLITION DEBRIS IN AN APPROVED OFF-SITE LANDFILL.
- 4. ASBESTOS OR HAZARDOUS MATERIAL, IF FOUND ON SITE, SHALL BE REMOVED BY A LICENSED HAZARDOUS MATERIAL CONTRACTOR. 5. THE CONTRACTOR SHALL PREPARE ALL MANIFEST DOCUMENTS AS REQUIRED PRIOR TO COMMENCEMENT OF DEMOLITION.
- 6. THE CONTRACTOR SHALL CUT AND PLUG, OR ARRANGE FOR THE APPROPRIATE UTILITY PROVIDER TO CUT AND PLUG, ALL SERVICE PIPING AT THE STREET LINE OR AT THE MAIN, AS REQUIRED BY THE UTILITY PROVIDER, OR AS OTHERWISE NOTED OR SHOWN ON THE CONTRACT DRAWINGS. ALL SERVICES MAY NOT BE SHOWN ON THIS PLAN. THE CONTRACTOR SHALL INVESTIGATE THE SITE PRIOR TO CONSTRUCTION TO DETERMINE THE EXTENT OF SERVICE PIPING TO BE REMOVED, CUT OR PLUGGED. THE CONTRACTOR SHALL PAY ALL UTILITY PROVIDER FEES FOR ABANDONMENTS AND REMOVALS.
- THE CONTRACTOR SHALL PROTECT ALL IRON PINS, AND PROPERTY CORNERS DURING DEMOLITION ACTIVITIES. ANY CONTRACTOR DISTURBED PINS, AND OR PROPERTY CORNERS, ETC. SHALL BE RESET BY A LICENSED LAND SURVEYOR AT THE EXPENSE OF THE CONTRACTOR.
- 8. THE CONTRACTOR SHALL STABILIZE THE SITE AND KEEP EROSION AND SEDIMENT CONTROL MEASURES IN PLACE UNTIL THE COMPLETION OF HIS WORK OR UNTIL THE COMMENCEMENT OF WORK BY THE SITE CONTRACTOR, WHICHEVER OCCURS FIRST, AS REQUIRED OR DEEMED NECESSARY BY THE ENGINEER OR OWNER'S REPRESENTATIVE. THE SITE CONTRACTOR SHALL ASSUME RESPONSIBILITY FOR THE MAINTENANCE OF EXISTING EROSION AND SEDIMENTATION CONTROLS AND FOR INSTALLATION OF ANY NEW EROSION AND SEDIMENTATION CONTROLS, AS PER THE SEDIMENT AND EROSION CONTROL PLAN, AT THAT TIME.
- 9. IF IMPACTED OR CONTAMINATED SOIL IS ENCOUNTERED BY THE CONTRACTOR, THE CONTRACTOR SHALL SUSPEND EXCAVATION WORK OF IMPACTED SOIL AND NOTIFY THE OWNER AND/OR OWNER'S ENVIRONMENTAL CONSULTANT PRIOR TO PROCEEDING WITH FURTHER WORK IN THE IMPACTED SOIL LOCATION UNTIL FURTHER INSTRUCTED BY THE OWNER AND/OR OWNER'S ENVIRONMENTAL CONSULTANT.
- 10. THE CONTRACTOR SHALL ADHERE TO ALL OSHA, FEDERAL, STATE AND LOCAL REGULATIONS WHEN OPERATING CRANES, BOOMS, HOISTS, ETC. IN PROXIMITY OF OVERHEAD ELECTRIC LINES. IF CONTRACTOR MUST OPERATE EQUIPMENT CLOSE TO ELECTRIC LINES CONTACT POWER COMPANY TO MAKE ARRANGEMENTS FOR PROPER SAFEGUARDS. ANY UTILITY PROVIDER FEES SHALL BE PAID BY THE CONTRACTOR.
- 11. CONTRACTOR SHALL PROVIDE AND MAINTAIN TRAFFIC CONTROL DEVICES FOR PROTECTION OF VEHICLES AND PEDESTRIANS CONSISTING OF DRUMS. LOCAL GOVERNING AUTHORITIES OR AS REQUIRED BY PERMIT STIPULATIONS. CONTRACTOR SHALL MAINTAIN ALL TRAFFIC LANES AND PEDESTRIAN
- INFORMATION ON EXISTING UTILITIES AND STORM DRAINAGE HAS BEEN COMPILED FROM AVAILABLE INFORMATION INCLUDING UTILITY PROVIDER AND MUNICIPAL RECORD MAPS AND/OR FIELD SURVEY AND IS NOT GUARANTEED CORRECT OR COMPLETE. UTILITIES AND STORM DRAINAGE SYSTEMS ARE ELEVATIONS OF ALL UTILITIES INCLUDING SERVICES AND STORM DRAINAGE SYSTEMS. PRIOR TO DEMOLITION OR CONSTRUCTION THE CONTRACTOR

- DRAINAGE SYSTEM LOCATIONS.
- BEGINNING DEMOLITION.

- LANDSCAPED AREAS DISTURBED DURING DEMOLITION TO THEIR ORIGINAL CONDITION OR BETTER TO THE SATISFACTION OF THE OWNER.
- PERFORMED.
- PAY UTILITY PROVIDER FEES.
- ENGINEER.
- STATE AND EVIDENCE OF SUCH SUBMITTED TO THE OWNER PRIOR TO INSTALLATION.
- 20. NO SALVAGE SHALL BE PERMITTED UNLESS PAID TO THE OWNER AS A CREDIT
- 23. BITUMINOUS AND CONCRETE PAVEMENT WITHIN THE LIMITS OF WORK ARE TO BE REMOVED UNLESS OTHERWISE NOTED.

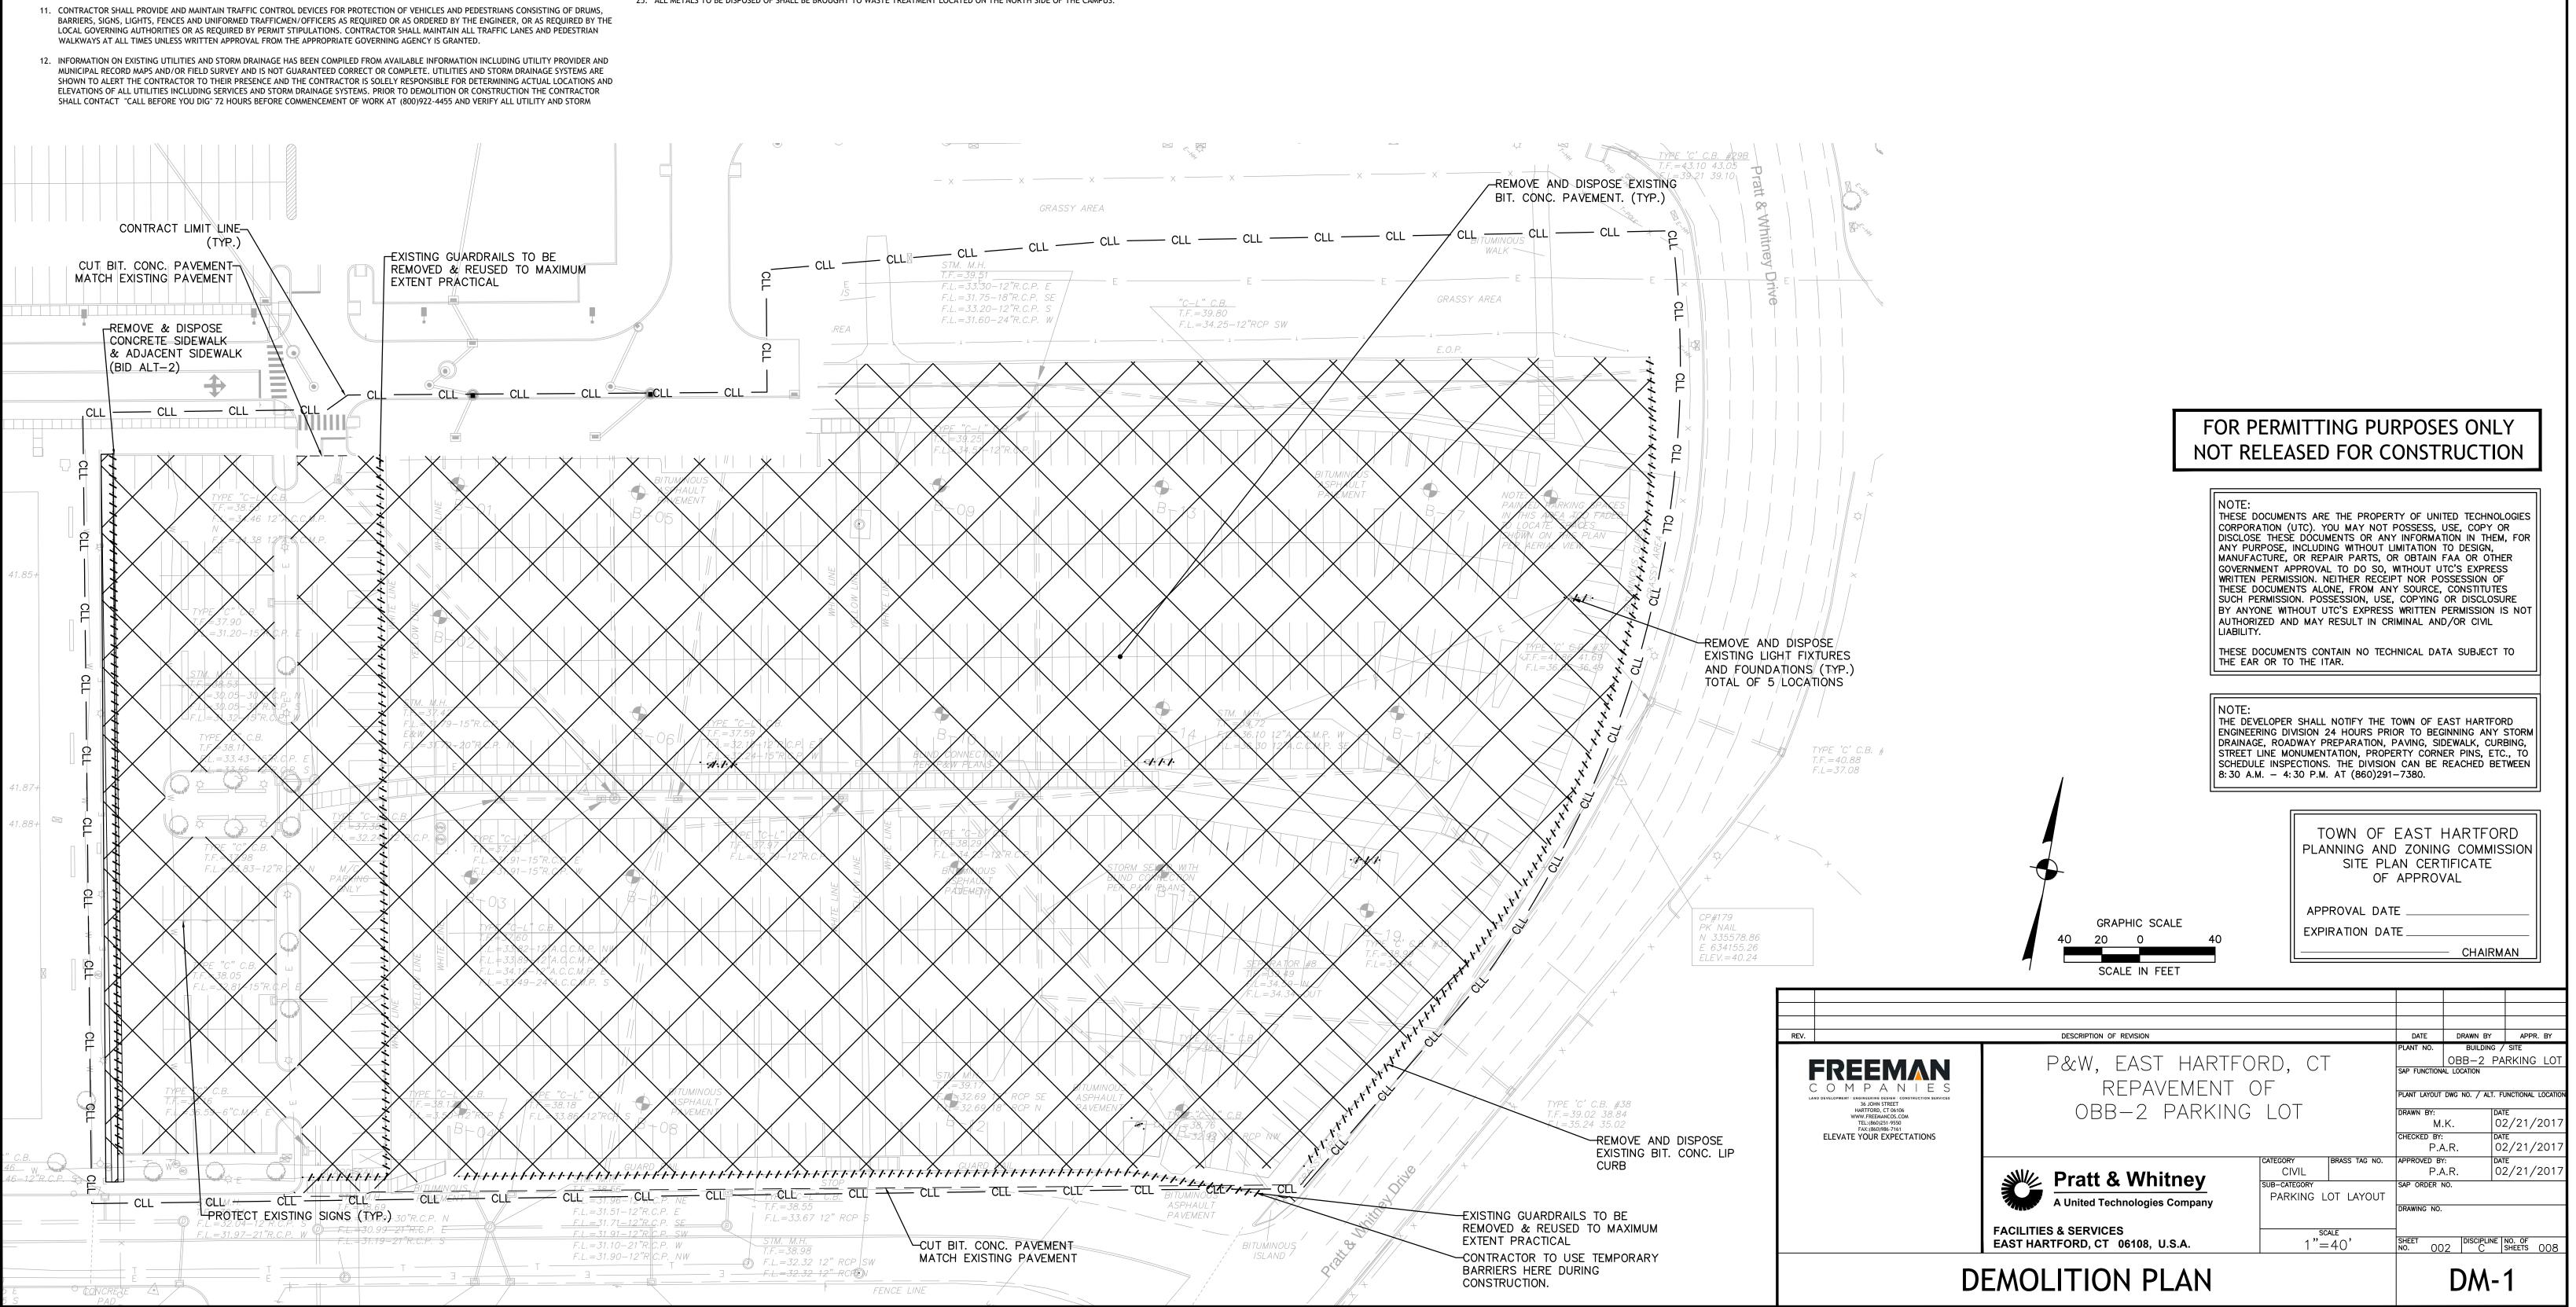

13. THE CONTRACTOR SHALL PROVIDE DISCONNECT NOTIFICATION IF NEEDED TO THE UTILITY COMPANIES AND TOWN AT LEAST THREE WEEKS PRIOR TO

14. BACK FILL DEPRESSIONS AREAS IN LOCATIONS NOT SUBJECT TO FURTHER EXCAVATION WITH SOIL MATERIAL CALLED FOR IN SITE SPECIFICATIONS AND COMPACT. FERTILIZE, SEED AND MULCH DISTURBED AREAS NOT SUBJECT TO FURTHER SITE CONSTRUCTION. 15. THE CONTRACTOR SHALL RESTORE ANY UTILITY STRUCTURE, PIPE, CONDUIT, PAVEMENT, CURBING, SIDEWALKS, DRAINAGE STRUCTURE, SWALE OR

16. NO WORK ON THIS SITE SHALL BE INITIATED BY THE CONTRACTOR UNTIL A PRE-CONSTRUCTION MEETING WITH THE OWNER AND THE ENGINEER IS

17. THE CONTRACTOR SHALL ARRANGE FOR AND INSTALL TEMPORARY OR PERMANENT UTILITY CONNECTIONS WHERE INDICATED ON PLAN OR AS REQUIRED. MAINTAIN UTILITY SERVICES TO BUILDINGS TO REMAIN. CONTRACTOR TO COORDINATE WITH UTILITY PROVIDERS FOR INSTALLATION AND

18. THE CONTRACTOR SHALL NOT COMMENCE DEMOLITION OR UTILITY DISCONNECTIONS UNTIL AUTHORIZED TO DO SO BY THE OWNER AND/OR

19. THE CONTRACTOR OR DEMOLITION CONTRACTOR SHALL INSTALL TEMPORARY SHEETING OR SHORING AS NECESSARY TO PROTECT NEW BUILDINGS AND UTILITIES DURING CONSTRUCTION AND DEMOLITION. SHEETING OR SHORING SHALL BE DESIGNED BY A PROFESSIONAL ENGINEER, LICENSED IN THIS


21. ENGINEER IS NOT RESPONSIBLE FOR SITE SAFETY MEASURES TO BE EMPLOYED DURING CONSTRUCTION. THE ARCHITECT AND ENGINEER HAS NO CONTRACTUAL DUTY TO CONTROL THE SAFEST METHODS OR MEANS OF THE WORK, JOBSITE RESPONSIBILITIES, SUPERVISION OF PERSONNEL OR TO SUPERVISE SAFETY, AND DO NOT VOLUNTARILY ASSUME ANY SUCH DUTY OR RESPONSIBILITY.


22. THE CONTRACTOR SHALL COMPLY WITH OSHA CFR29 PART 1926 FOR EXCAVATION, TRENCHING, AND TRENCH PROTECTION REQUIREMENTS.

24. ALL LANDSCAPING, TREES AND OTHER VEGETATION WITHIN THE LIMITS OF WORK SHALL BE REMOVED, UNLESS OTHERWISE NOTED.

25. ALL METALS TO BE DISPOSED OF SHALL BE BROUGHT TO WASTE TREATMENT LOCATED ON THE NORTH SIDE OF THE CAMPUS.


LEGEND

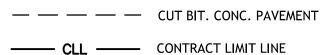


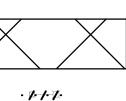

EXISTING BIT. CONCRETE PAVEMENT TO BE REMOVED TO A MIN. DEPTH OF 18 INCHES

EXISTING STRUCTURE, FEATURE, AND FOUNDATION TO BE REMOVED

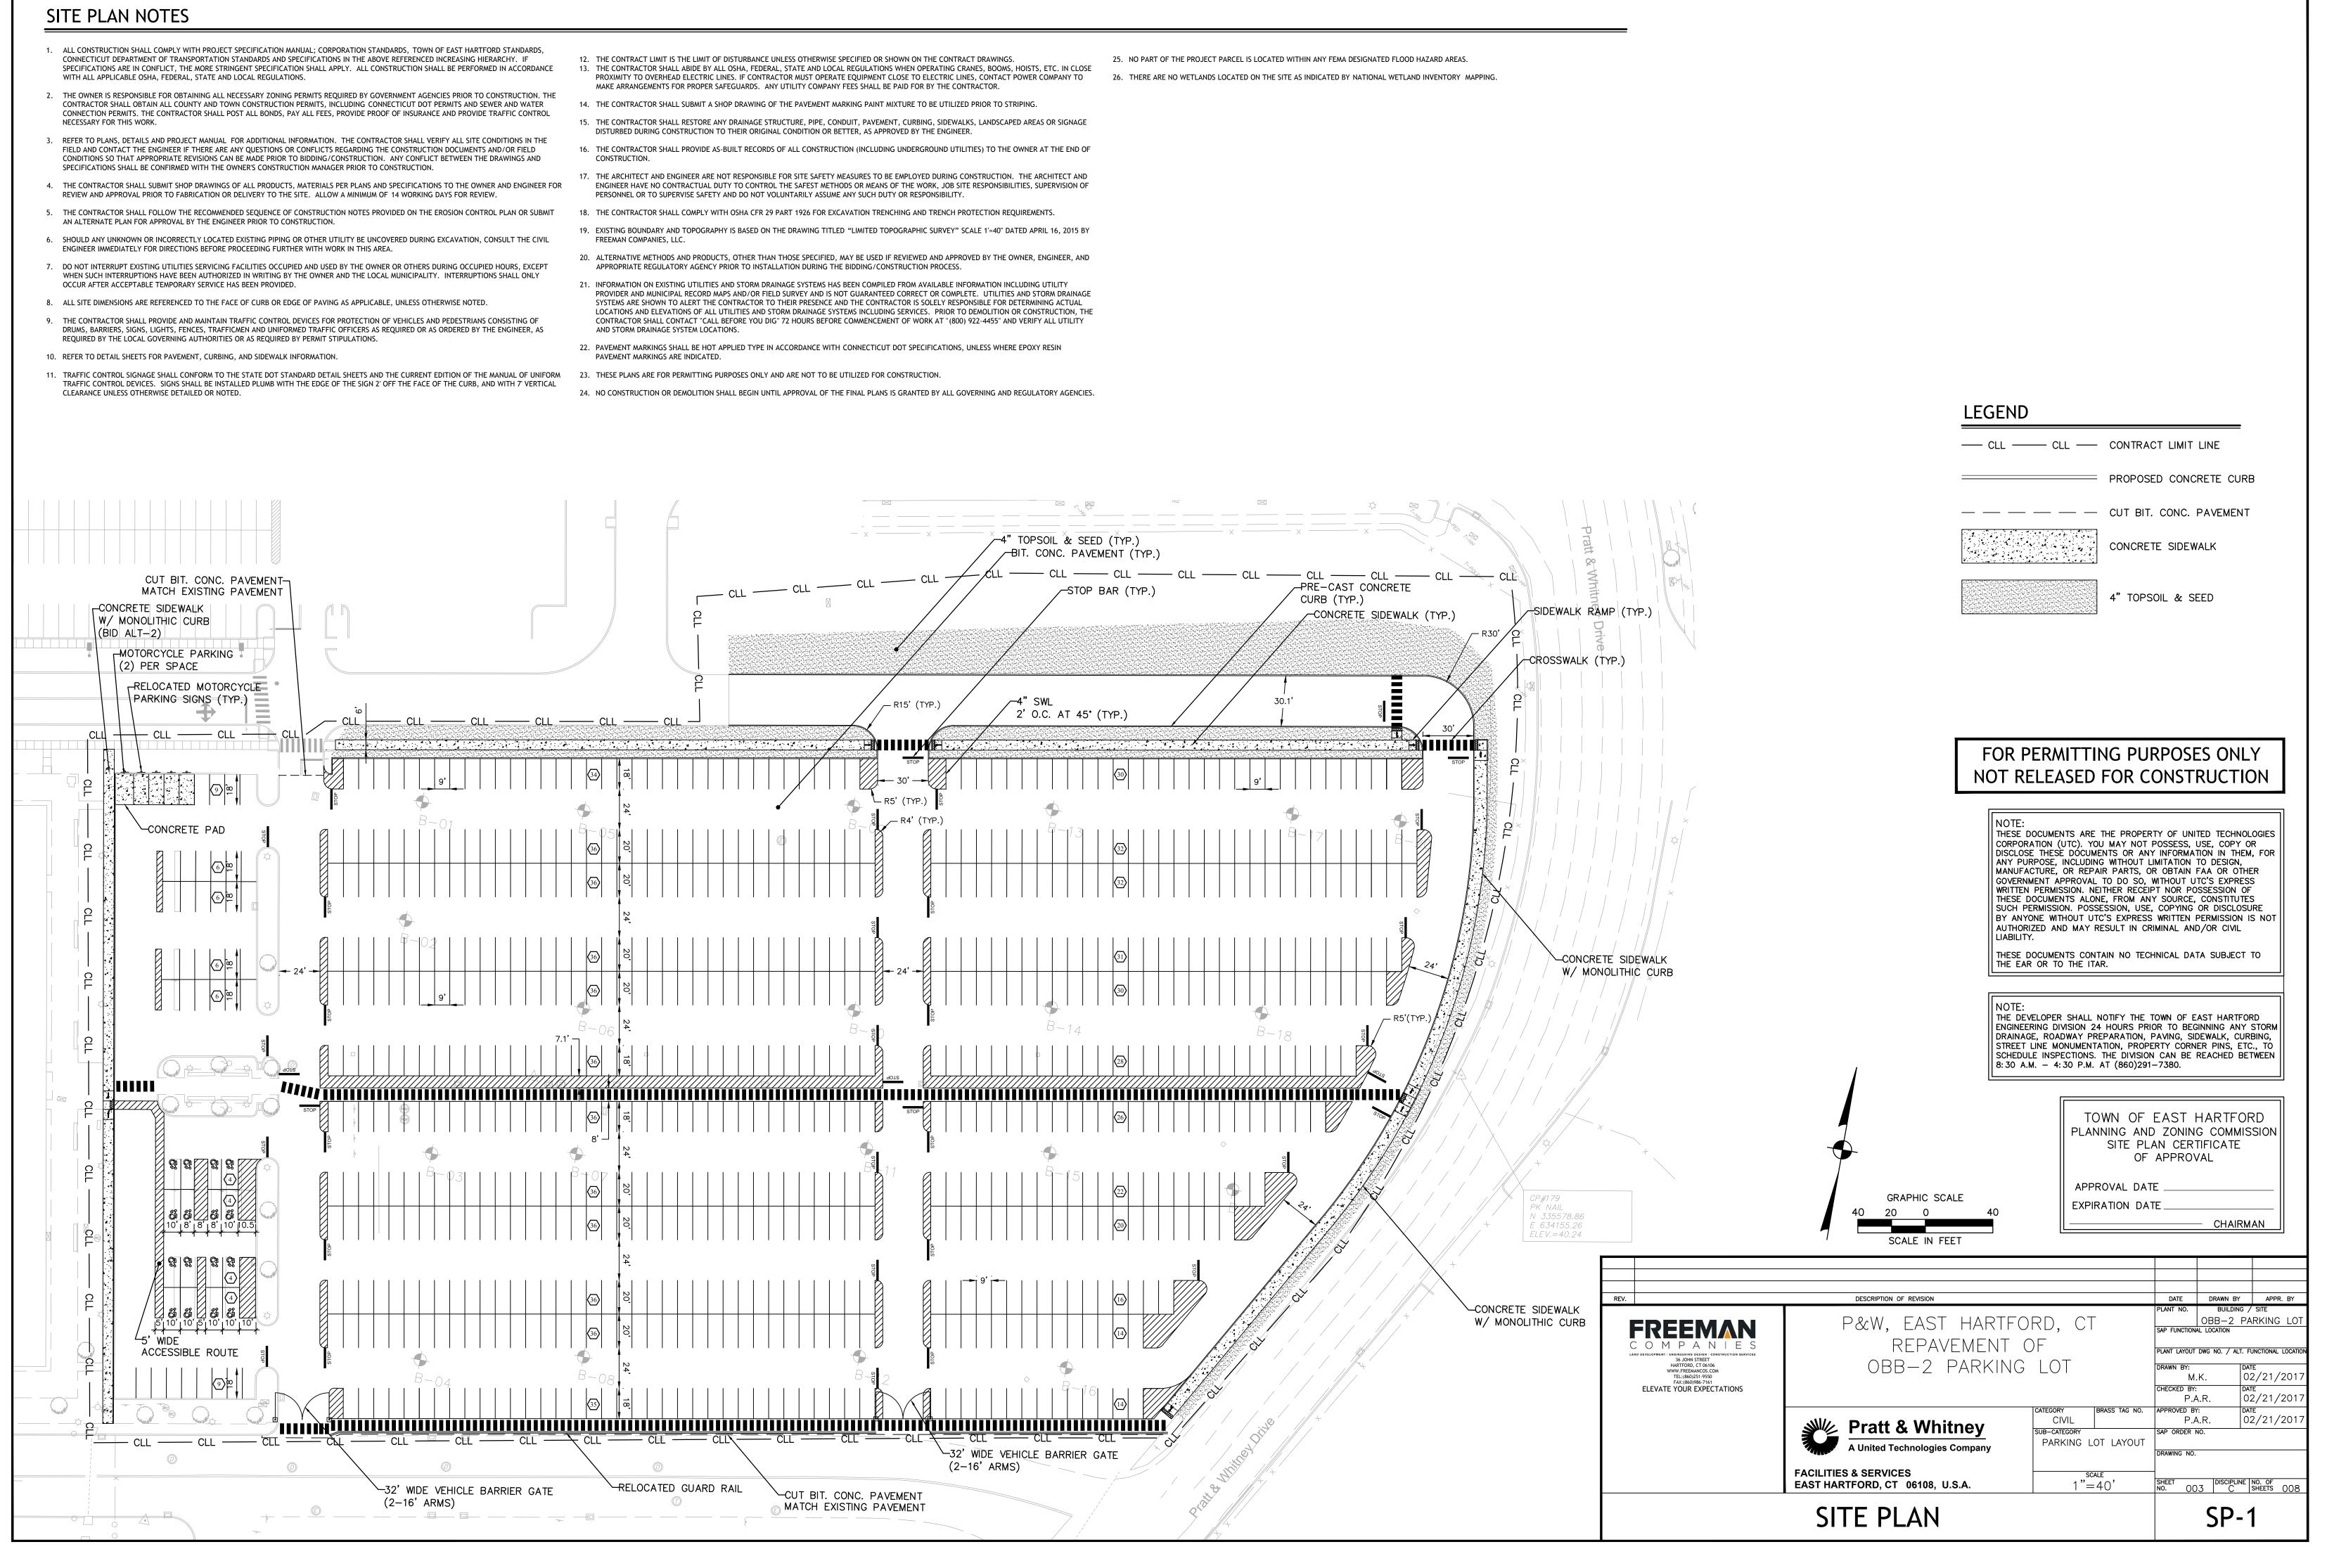

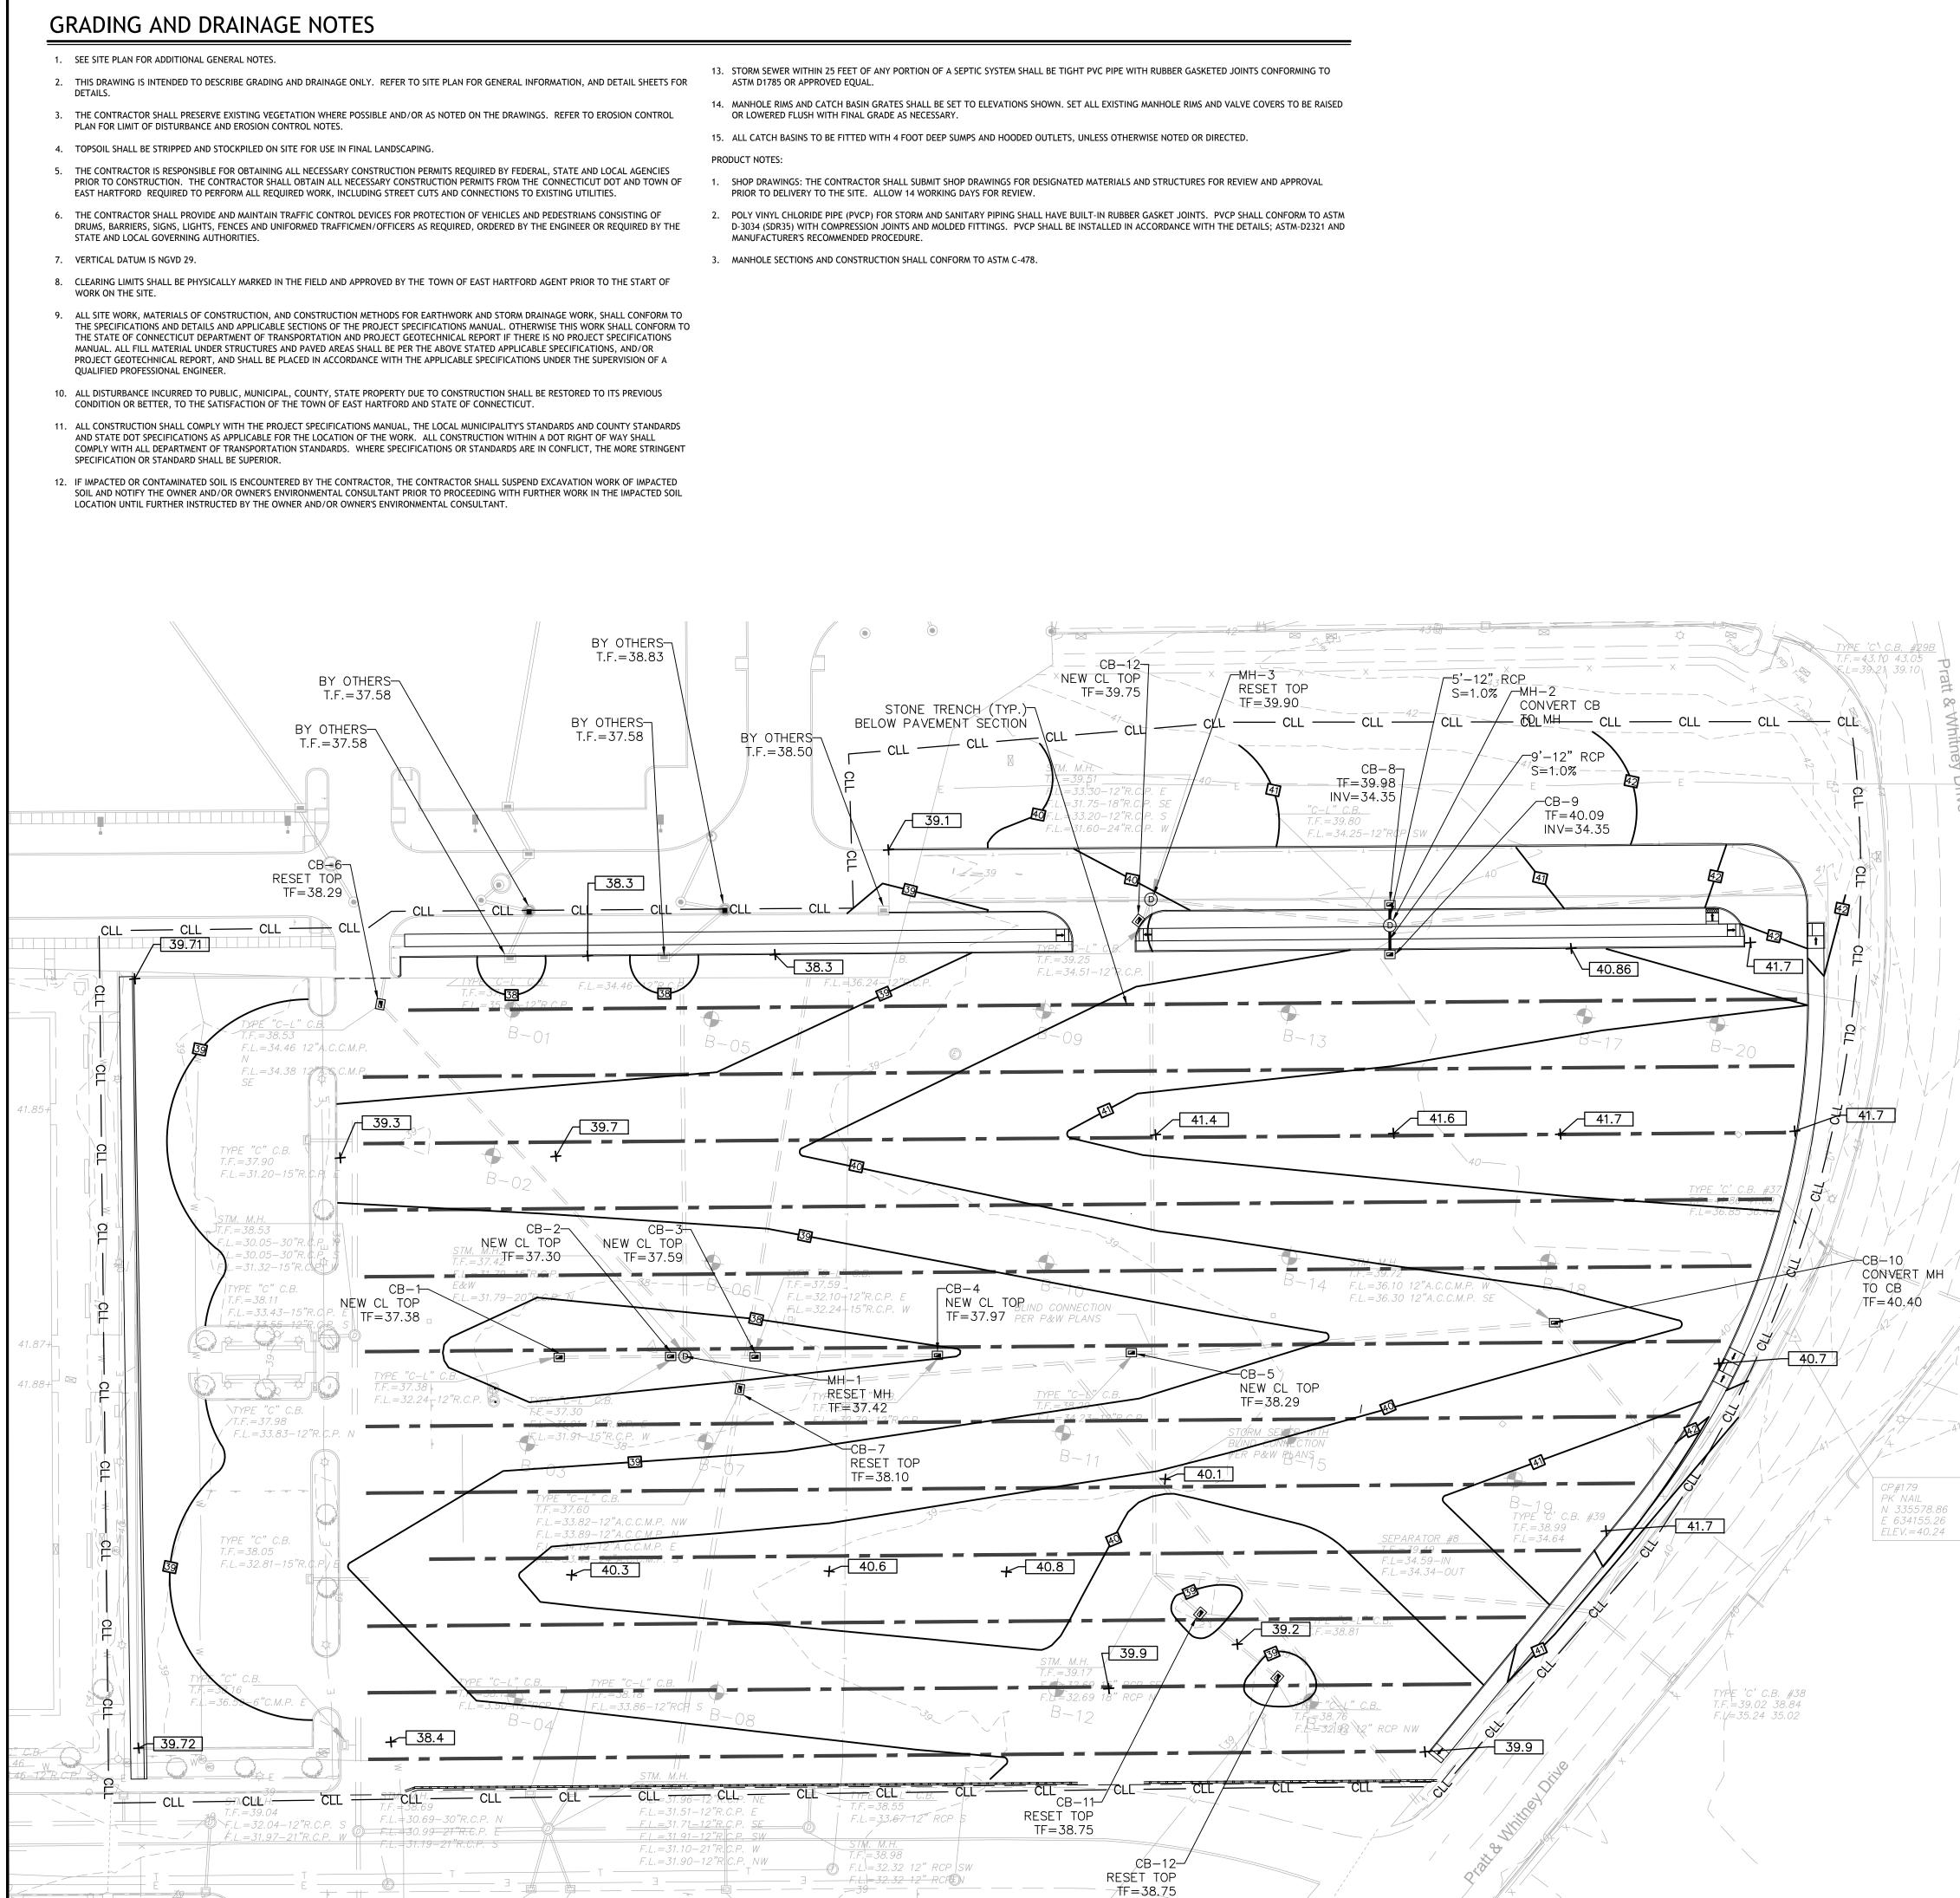


		PERMITTING PU RELEASED FOR C	
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TYPE 'C' C.B. ; T.F.=40.88 F.L=37.08	ENGINE DRAIN/ STREE SCHED	EVELOPER SHALL NOTIFY THE	IOR TO BEGINNING ANY STORM PAVING, SIDEWALK, CURBING, ERTY CORNER PINS, ETC., TO N CAN BE REACHED BETWEEN
+	GRAPHIC SCALE	PLANNING ANI SITE PL	
	40 20 0 40 SCALE IN FEET		CHAIRMAN
REV. FREEMANN A JOHN STREET HARTFORD, CT 06106 WWW.FREEMANCOS.COM TEL:(660)251-7550 FAX:(660)254-7550 FAX:(660)254-7550 FAX:(600)254-7561 FAX:(600)254-7561	DESCRIPTION OF REVISION P&W, EAST HARTFO REPAVEMENT OBB-2 PARKING	OF	DATE DRAWN BY APPR. BY PLANT NO. BUILDING / SITE OBB-2 PARKING LOT SAP FUNCTIONAL LOCATION PLANT LAYOUT DWG NO. / ALT. FUNCTIONAL LOCATION DRAWN BY: DATE C.B. 02/21/2017 CHECKED BY: DATE P.A.R. 02/21/2017
	FACILITIES & SERVICES EAST HARTFORD, CT 06108, U.S.A.	CATEGORY CIVIL SUB-CATEGORY PARKING LOT LAYOUT SCALE 1"=40'	APPROVED BY: P.A.R. DATE 02/21/2017 SAP ORDER NO. DRAWING NO. SHEET NO. 004 DISCIPLINE NO. OF SHEETS 008
GRADIN	G AND DRAINAGE P	LAN	GD-1

LEGEND


— — 50 — — —	EXISTING CONTOURS
50	PROPOSED CONTOURS
41.7	PROPOSED SPOT GRADE
— CLL —— CLL —	CONTRACT LIMIT LINE
	PROPOSED STONE TRENCH
	PROPOSED STORM LINE
	PROPOSED CATCH BASIN AND CB TOP

PROPOSED STORM MANHOLE

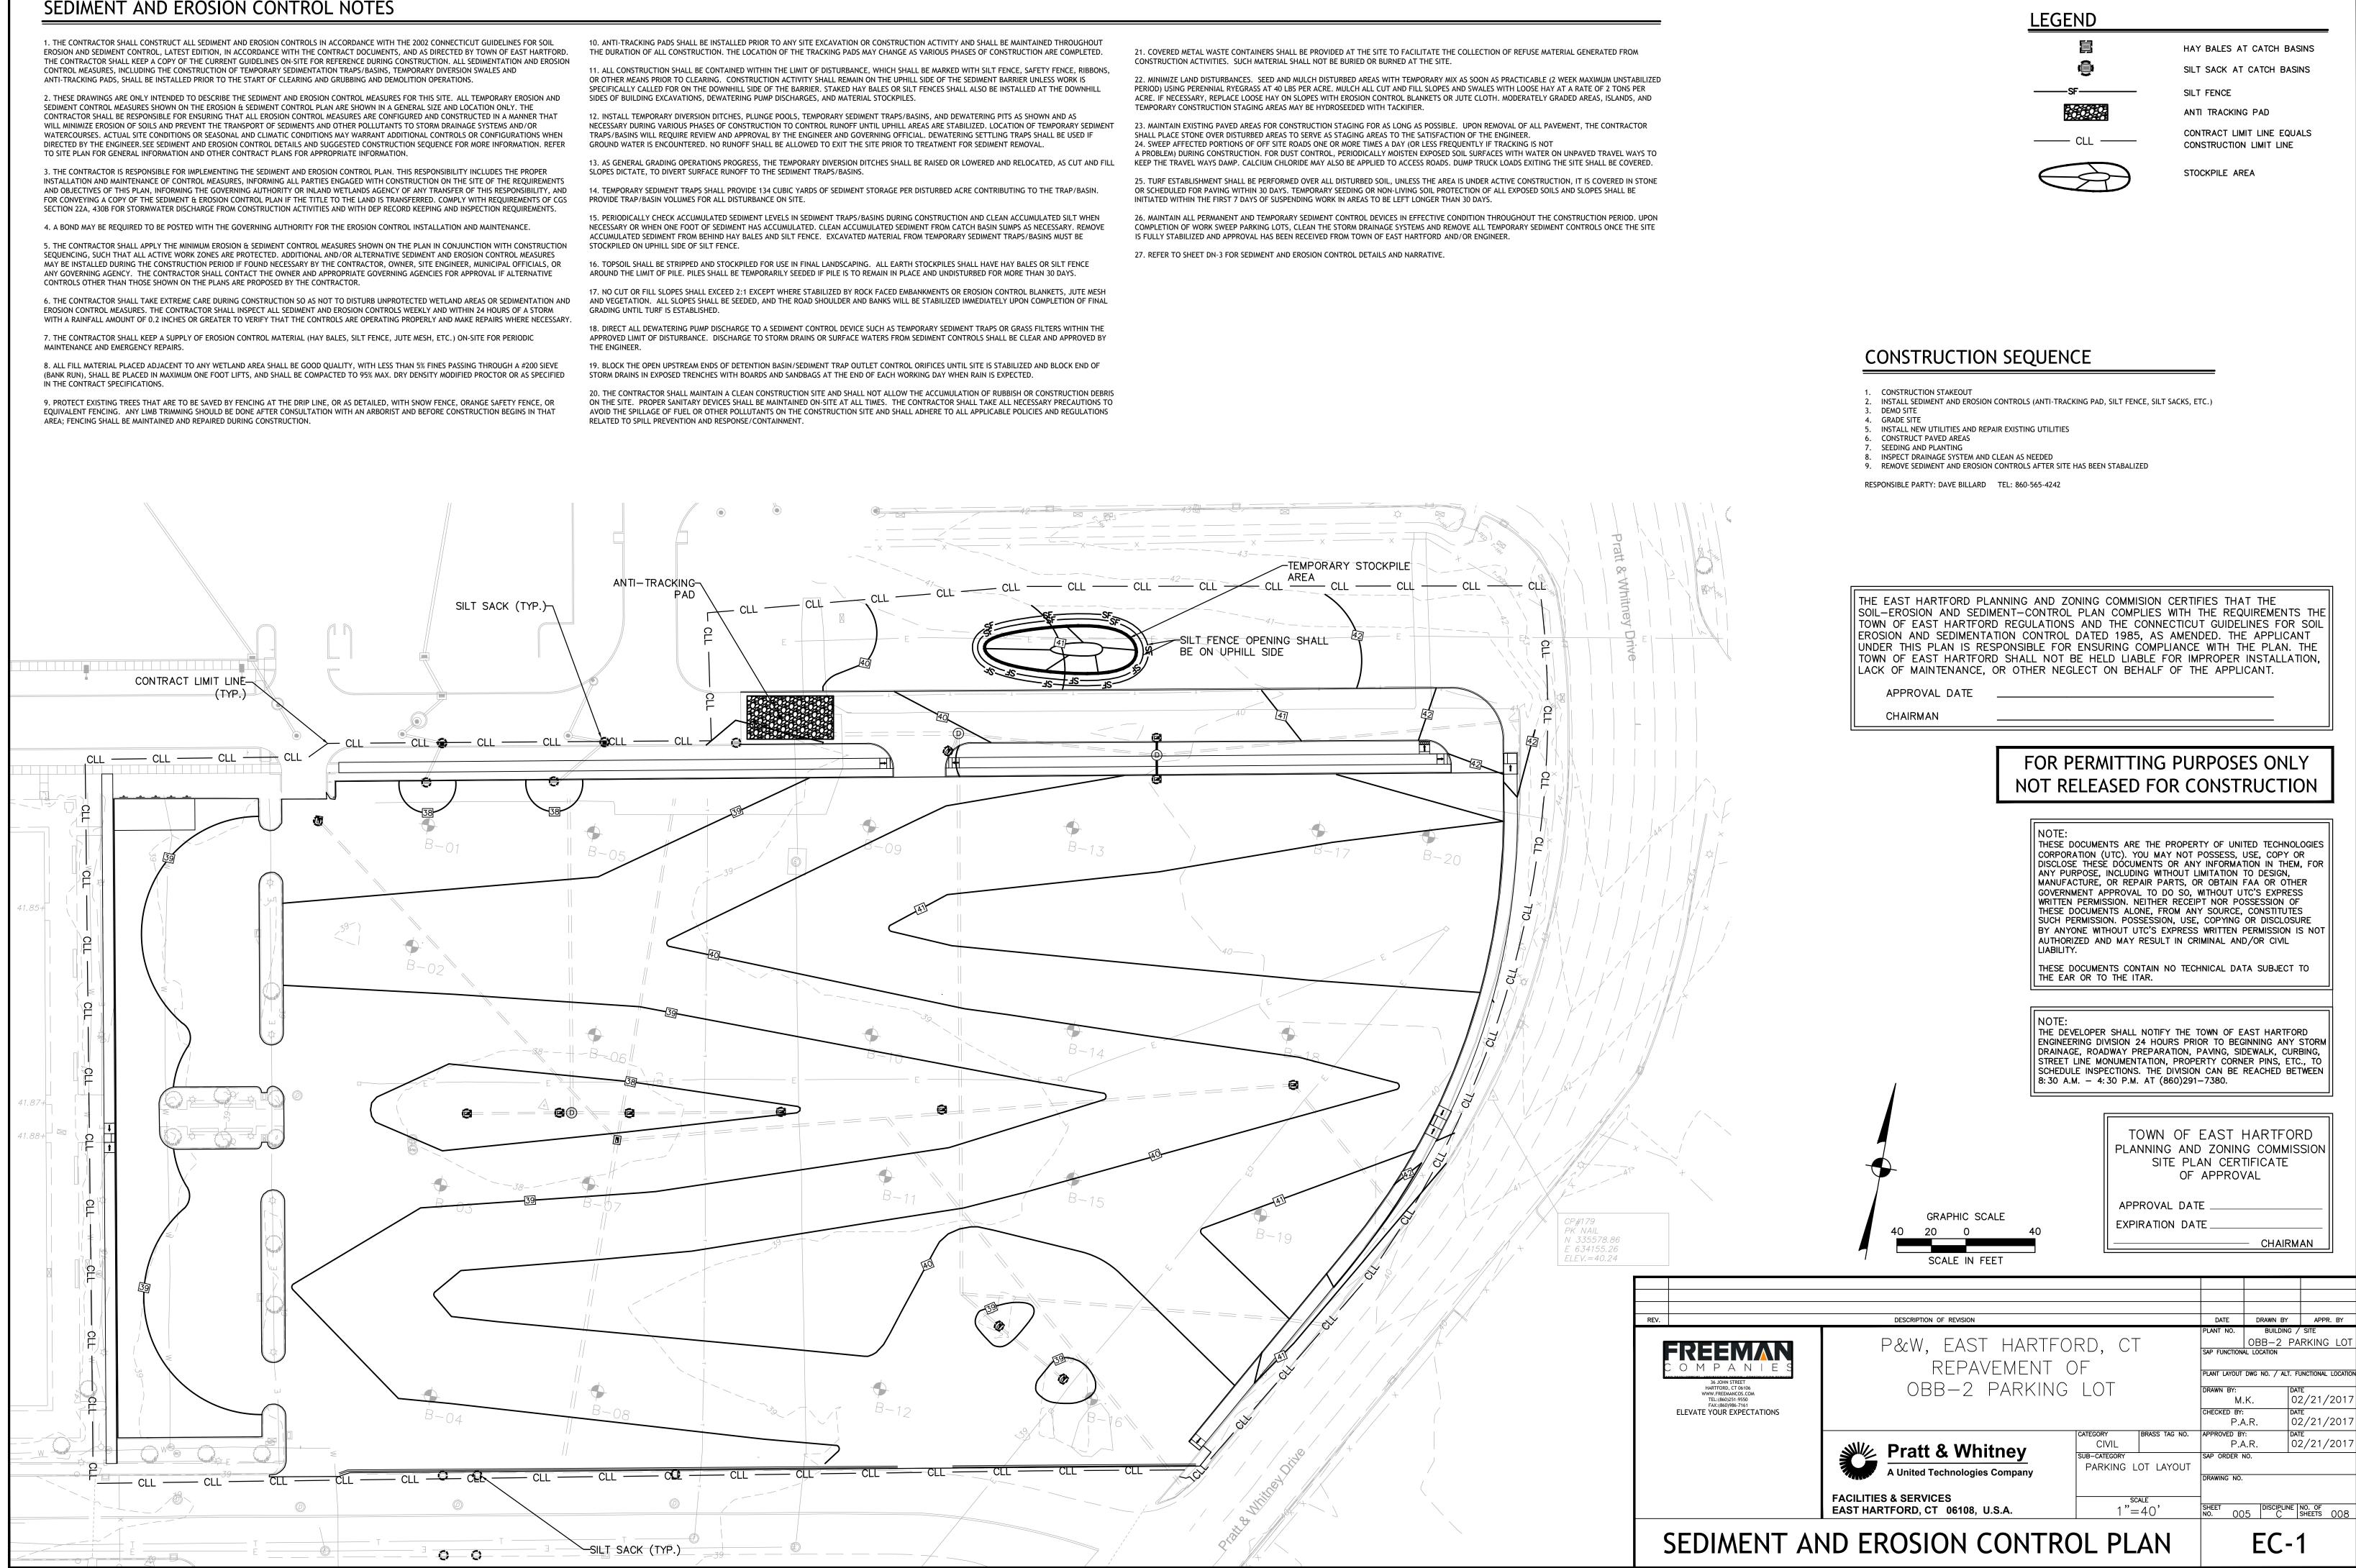




PR-A2 -1-1/4"c

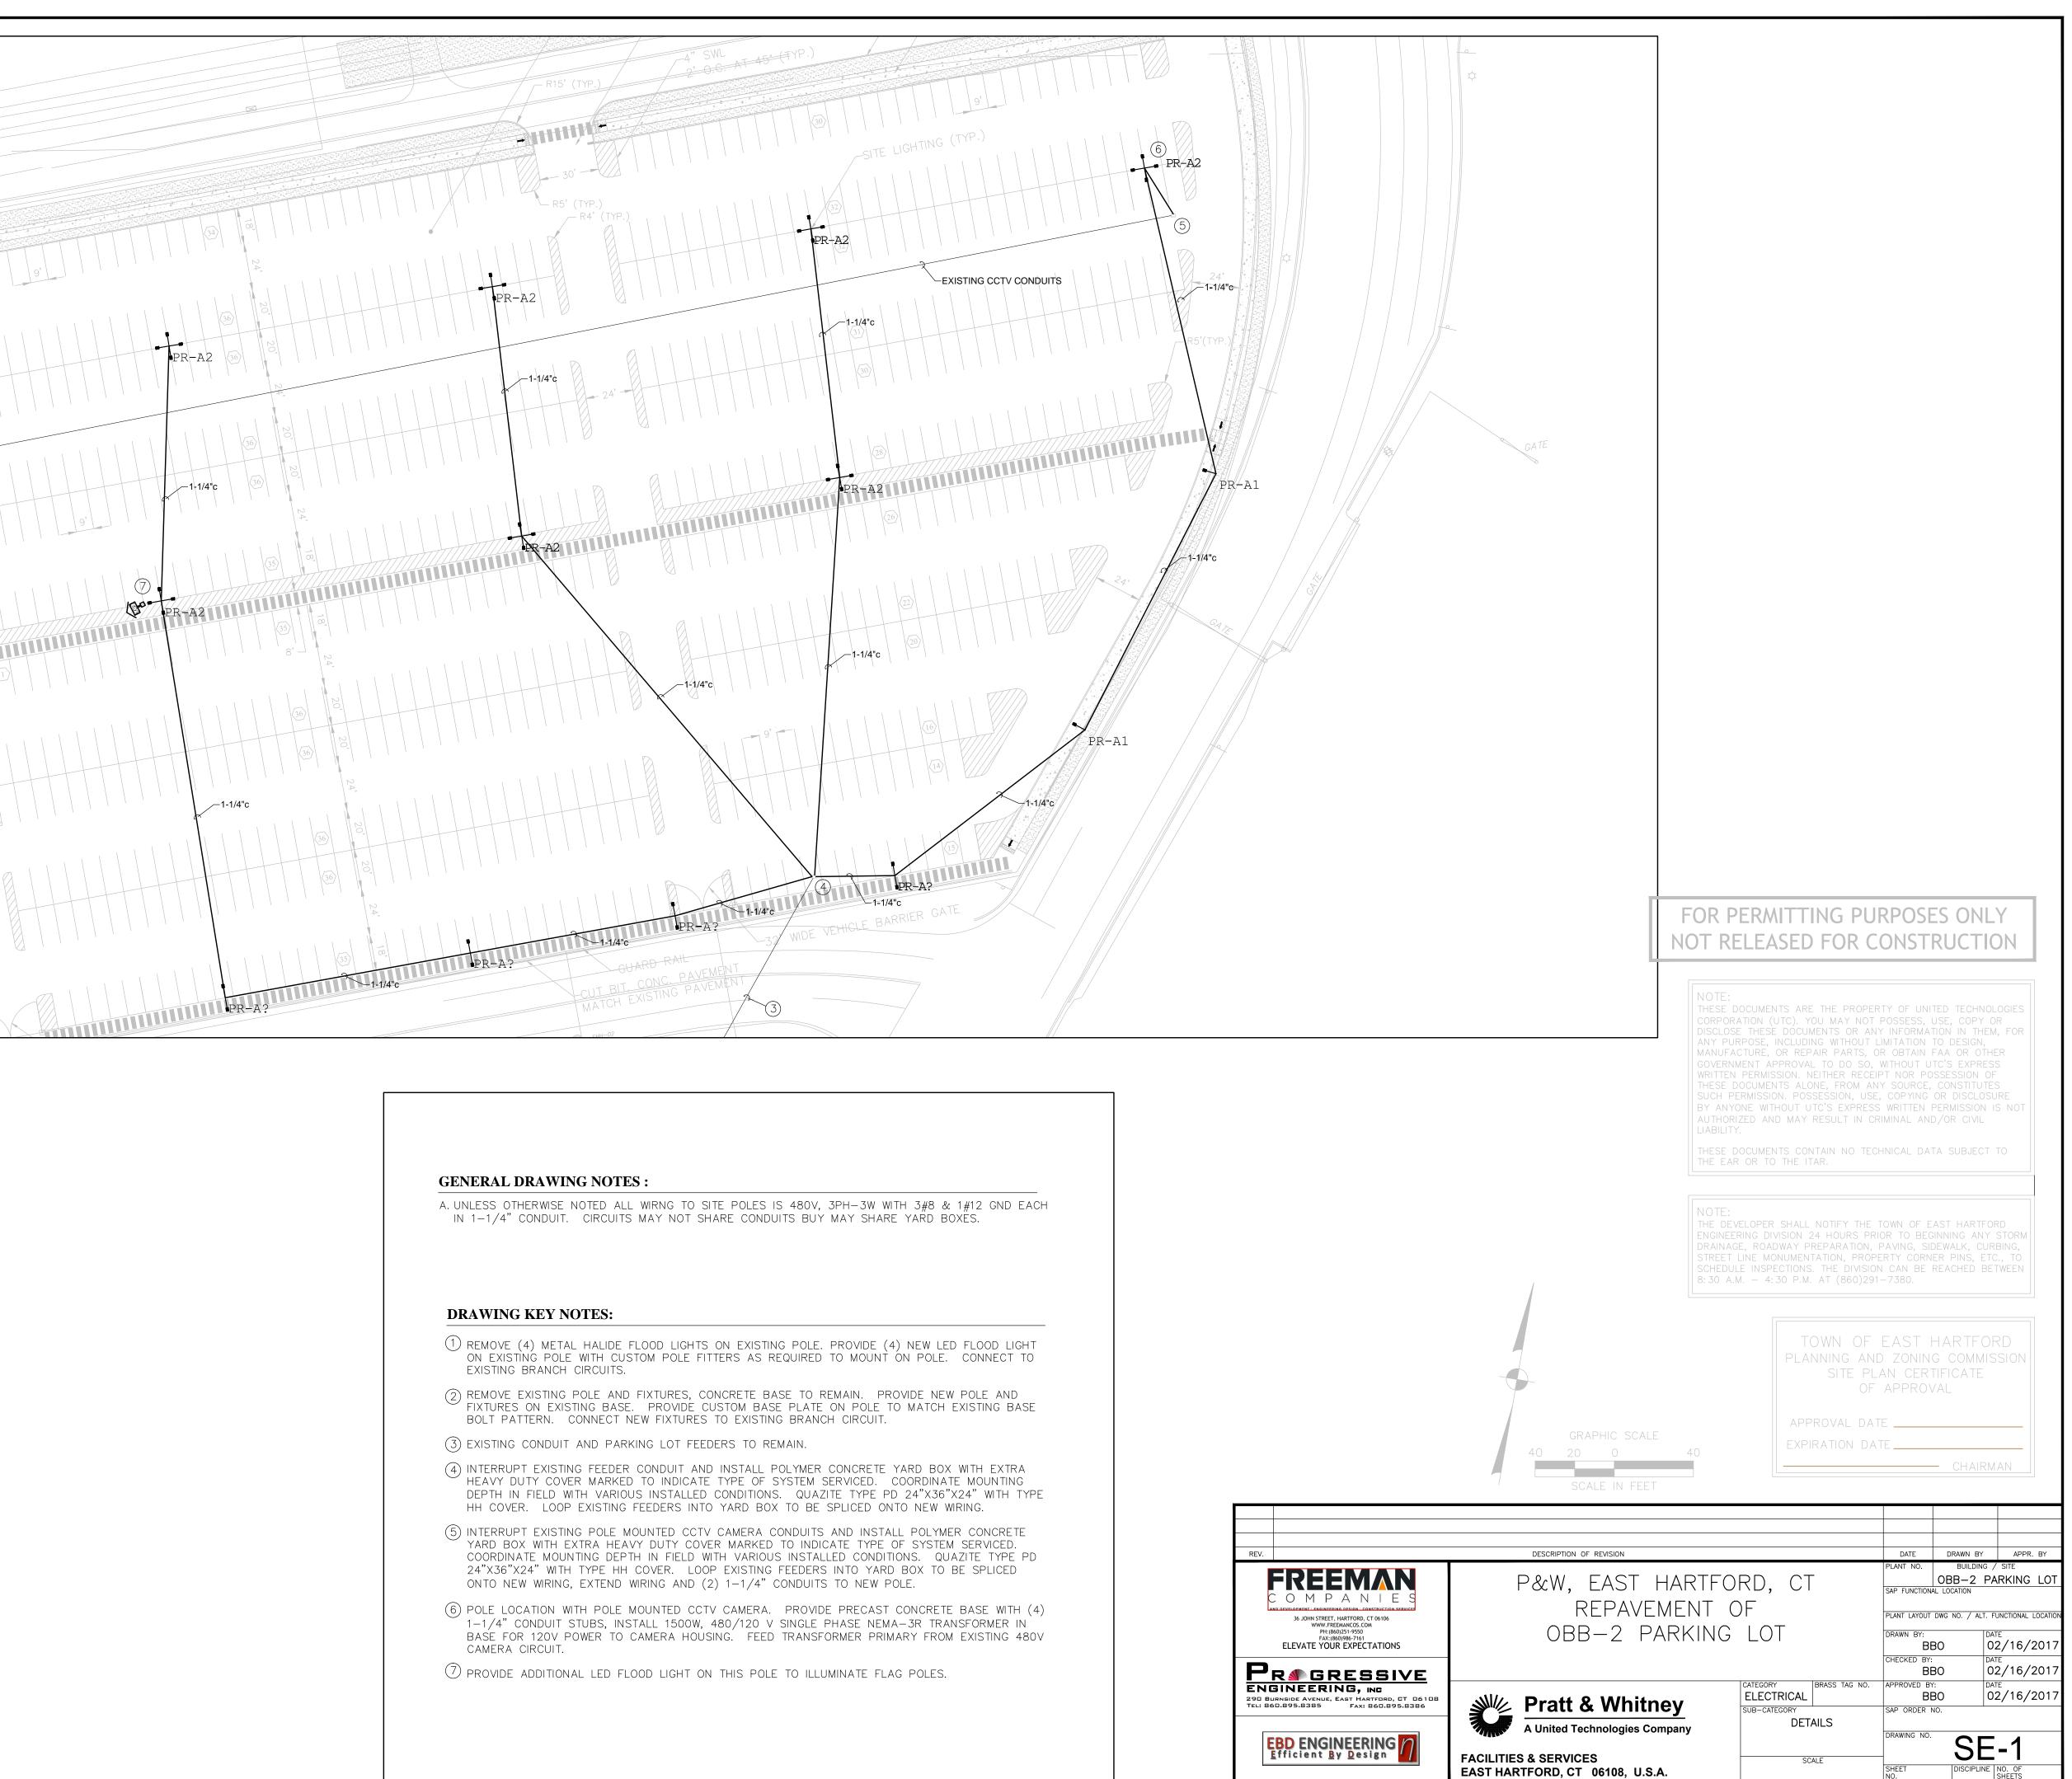

SITE LIGHTING ELECTRICAL PLAN - NORTH

DISCIPLINE NO. OF SHEETS

SUBSTATION 63 我"保健日、 B 6 spaces

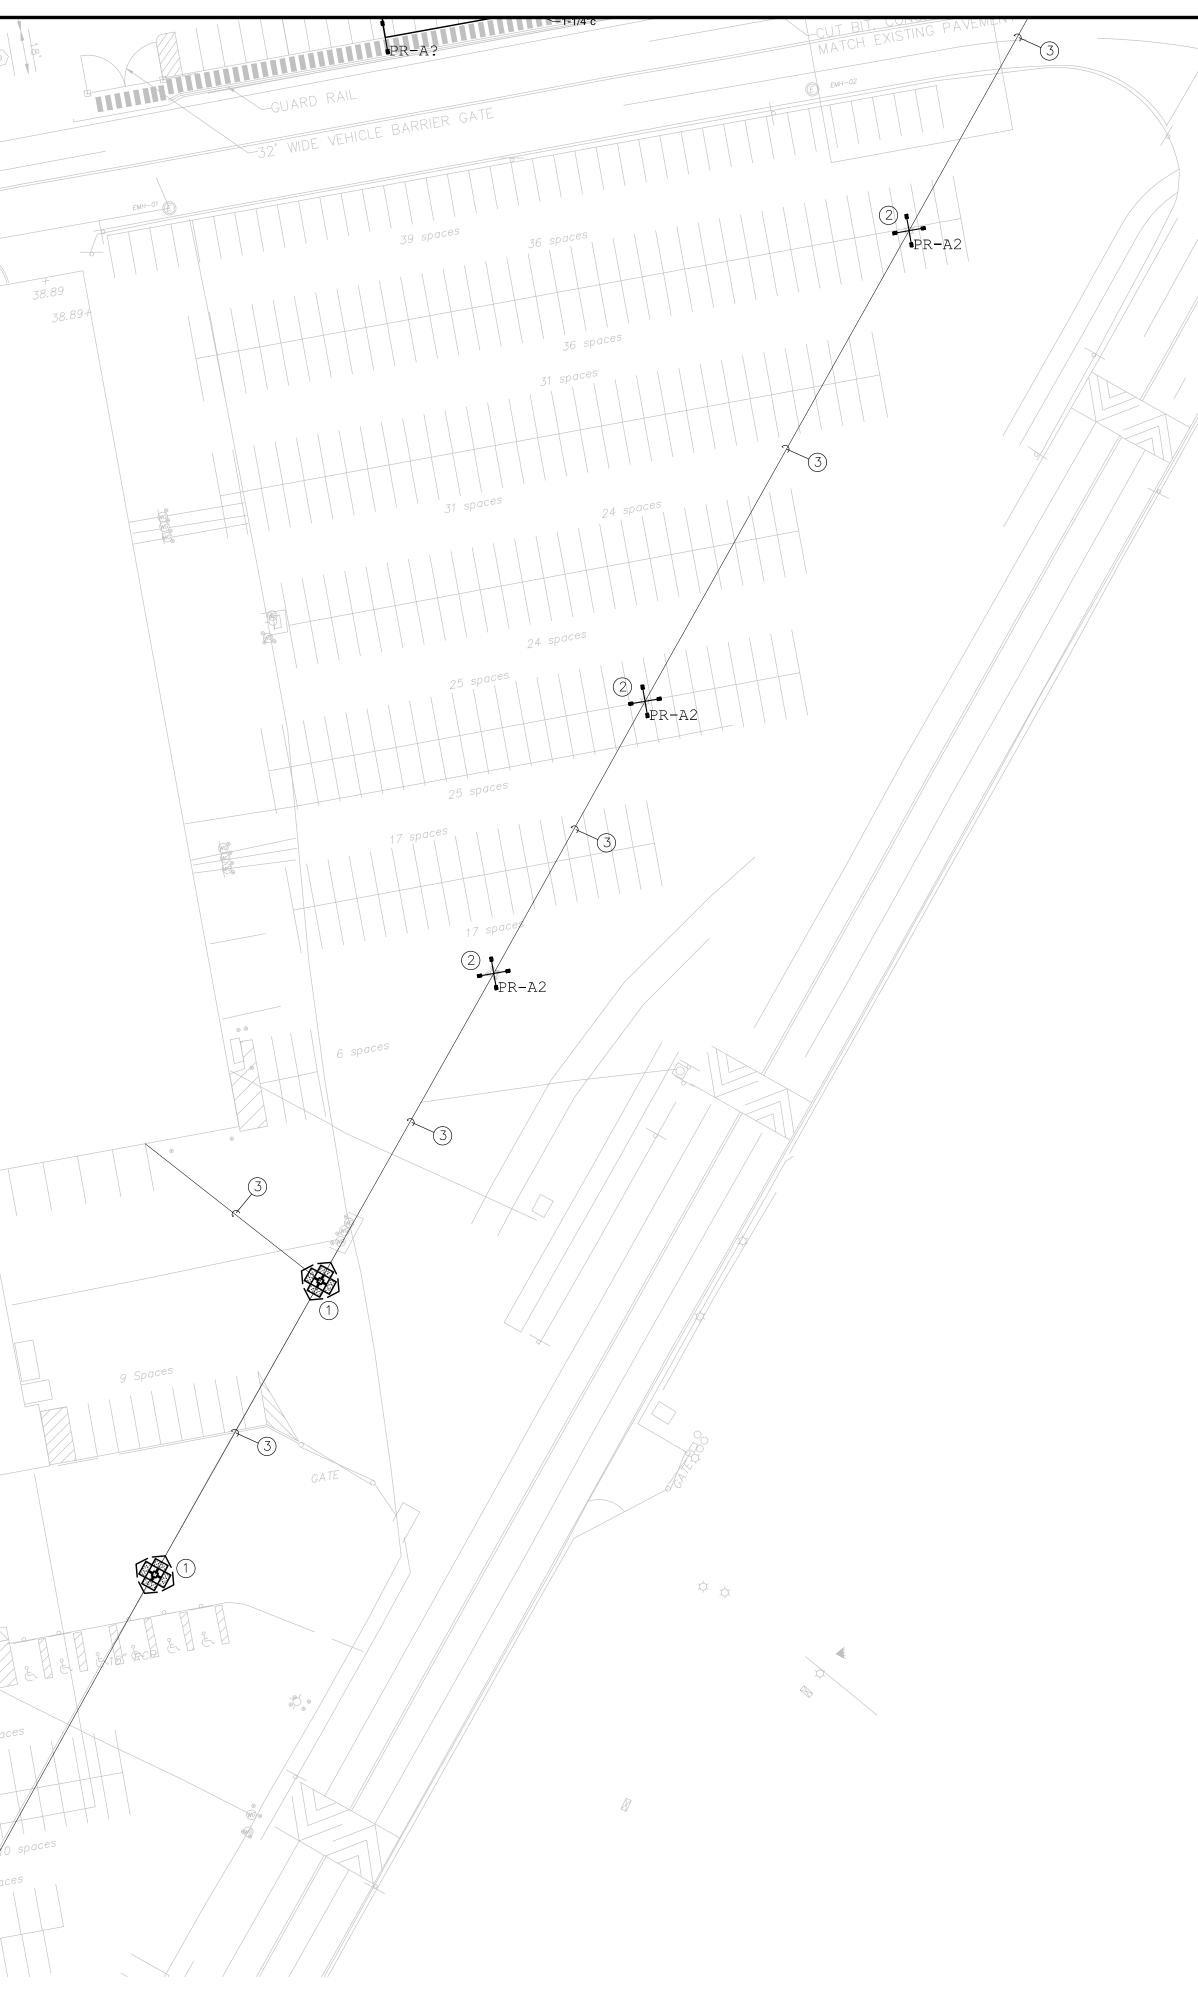


	NLESS OTHERWISE NOTED ALL WIRNG TO SITE POLES IS 480V, $3PH-3W$ with $3\#8 \& 1\#12$ GND EAC N $1-1/4$ " CONDUIT. CIRCUITS MAY NOT SHARE CONDUITS BUY MAY SHARE YARD BOXES.
D	RAWING KEY NOTES:
1	REMOVE (4) METAL HALIDE FLOOD LIGHTS ON EXISTING POLE. PROVIDE (4) NEW LED FLOOD LIGHT ON EXISTING POLE WITH CUSTOM POLE FITTERS AS REQUIRED TO MOUNT ON POLE. CONNECT TO EXISTING BRANCH CIRCUITS.
2	REMOVE EXISTING POLE AND FIXTURES, CONCRETE BASE TO REMAIN. PROVIDE NEW POLE AND FIXTURES ON EXISTING BASE. PROVIDE CUSTOM BASE PLATE ON POLE TO MATCH EXISTING BASE BOLT PATTERN. CONNECT NEW FIXTURES TO EXISTING BRANCH CIRCUIT.
3	EXISTING CONDUIT AND PARKING LOT FEEDERS TO REMAIN.
4	NINTERRUPT EXISTING FEEDER CONDUIT AND INSTALL POLYMER CONCRETE YARD BOX WITH EXTRA HEAVY DUTY COVER MARKED TO INDICATE TYPE OF SYSTEM SERVICED. COORDINATE MOUNTING DEPTH IN FIELD WITH VARIOUS INSTALLED CONDITIONS. QUAZITE TYPE PD 24"X36"X24" WITH TYPE HH COVER. LOOP EXISTING FEEDERS INTO YARD BOX TO BE SPLICED ONTO NEW WIRING.
5	NINTERRUPT EXISTING POLE MOUNTED CCTV CAMERA CONDUITS AND INSTALL POLYMER CONCRETE YARD BOX WITH EXTRA HEAVY DUTY COVER MARKED TO INDICATE TYPE OF SYSTEM SERVICED. COORDINATE MOUNTING DEPTH IN FIELD WITH VARIOUS INSTALLED CONDITIONS. QUAZITE TYPE PD 24"X36"X24" WITH TYPE HH COVER. LOOP EXISTING FEEDERS INTO YARD BOX TO BE SPLICED ONTO NEW WIRING, EXTEND WIRING AND (2) 1–1/4" CONDUITS TO NEW POLE.
6	POLE LOCATION WITH POLE MOUNTED CCTV CAMERA. PROVIDE PRECAST CONCRETE BASE WITH (4 1-1/4" CONDUIT STUBS, INSTALL 1500W, 480/120 V SINGLE PHASE NEMA-3R TRANSFORMER IN BASE FOR 120V POWER TO CAMERA HOUSING. FEED TRANSFORMER PRIMARY FROM EXISTING 480 CAMERA CIRCUIT.
$\overline{7}$	PROVIDE ADDITIONAL LED FLOOD LIGHT ON THIS POLE TO ILLUMINATE FLAG POLES.


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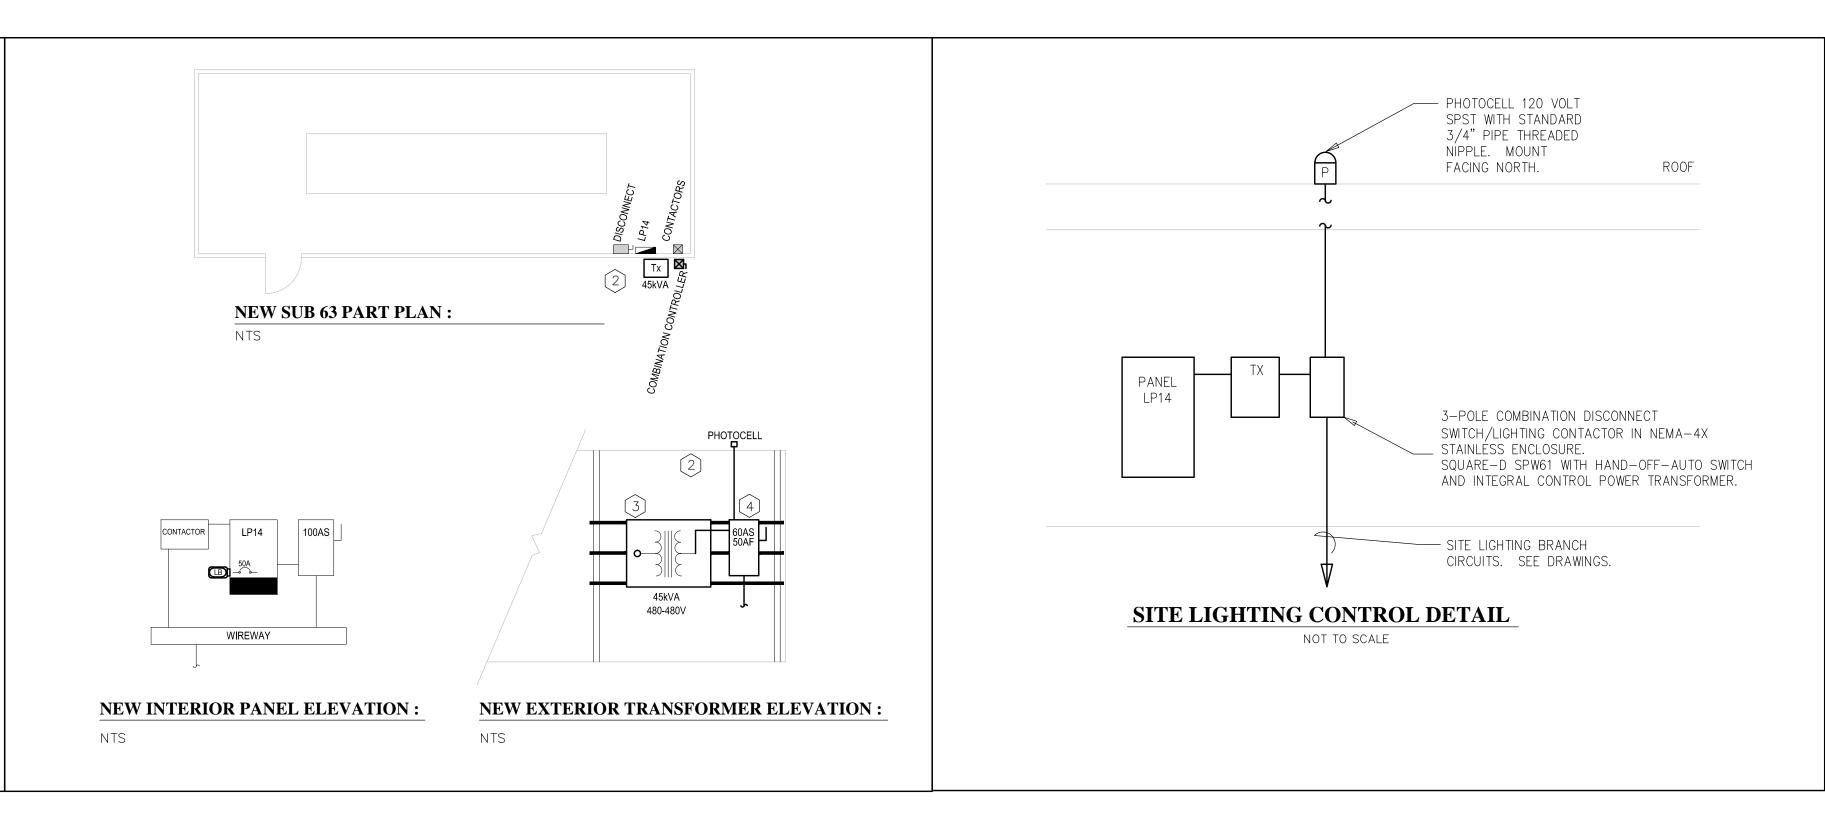
ANY PURPOSE, INCLUDING WITHOUT LIMITATION TO DESIGN, GOVERNMENT APPROVAL TO DO SO, WITHOUT UTC'S EXPRESS

THE DEVELOPER SHALL NOTIFY THE TOWN OF EAST HARTFORD ENGINEERING DIVISION 24 HOURS PRIOR TO BEGINNING ANY STORM 8:30 A.M. - 4:30 P.M. AT (860)291-7380.

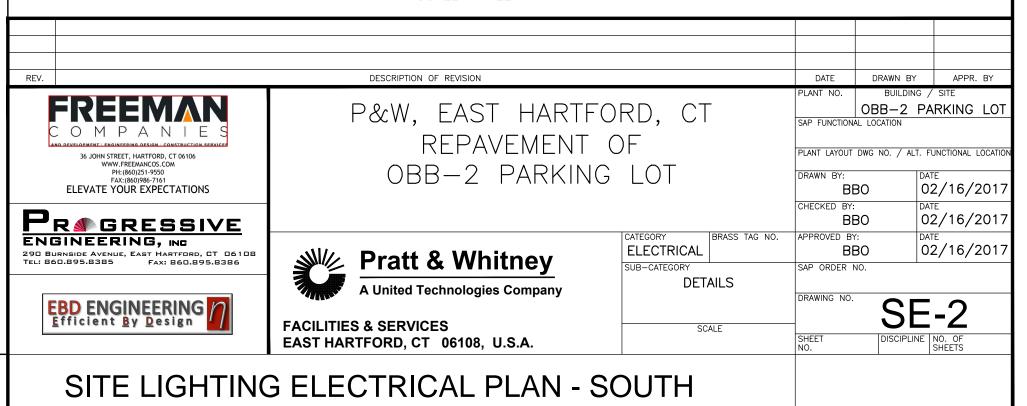

40 20 0 40



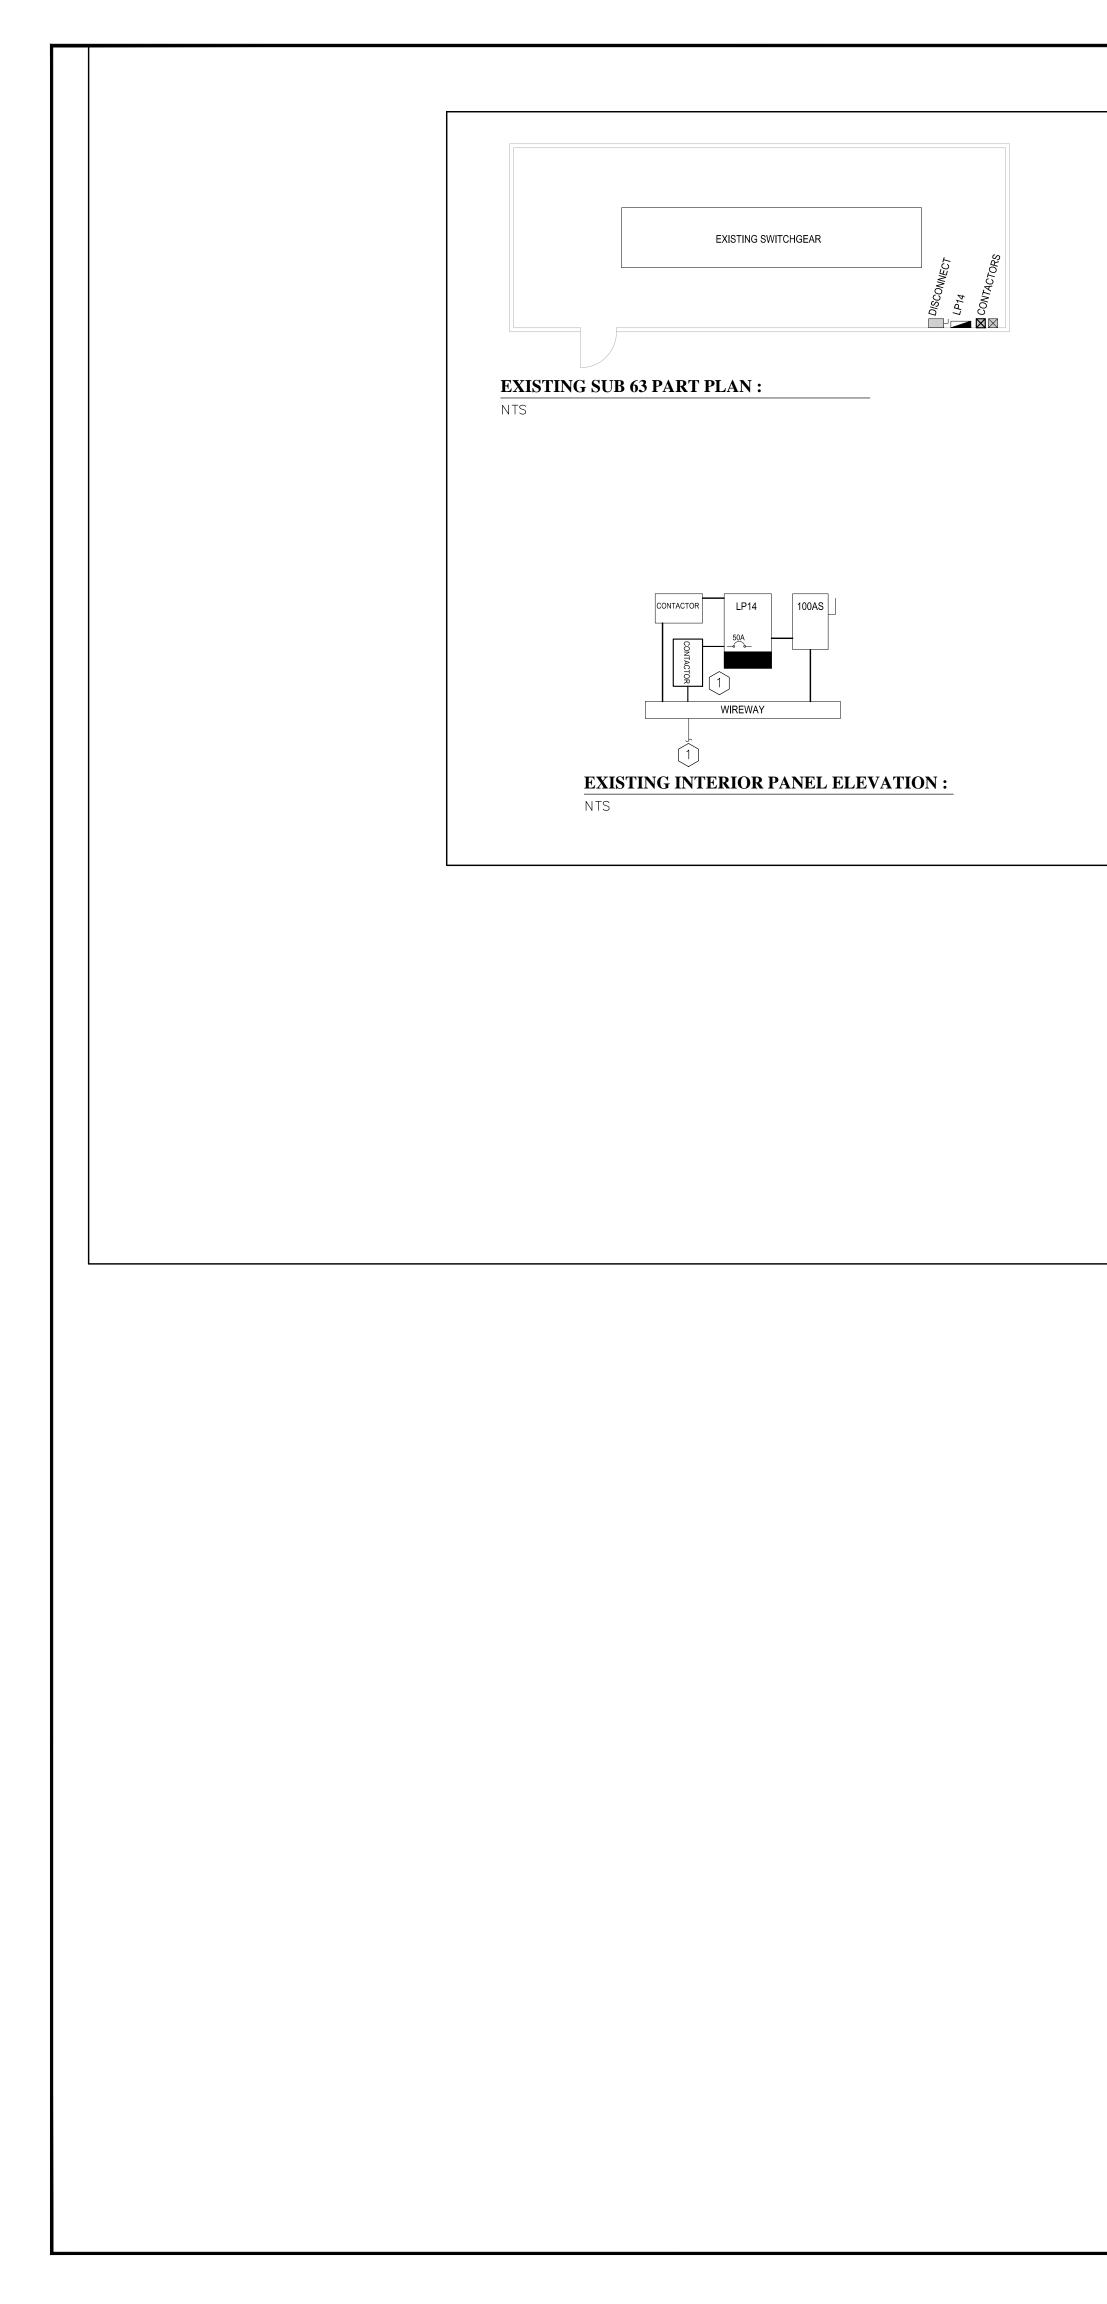

DRAWING KEY NOTES:

1 DISCONNECT EXISTING SITE LIGHTING FEEDER FROM EXISTING CONTACTOR AND REMOVE CONTACTOR. FEEDER IS TO BE REWORKED TO NEW CONTROLLER ON EXTERIOR OF BUILDING.

- 2 INSTALL NEW TRANSFORMER AND COMBINATION DISCONNECT SWTICH/CONTACTOR ON EXTERIOR OF SUBSTATION 63. PROVIDE (3) 2"x3"x3/16" GALVANIZED STEEL TUBES SPANNING BETWEEN INTERIOR STRUCTURAL STEEL OF SUBSTATION TO MOUNT TRANSFORMER AND CONTROLLER.
- $\overline{(3)}$ NEW 45kVA 480/480V NEMA-3R TRANSFORMER, FEED FROM EXISTING 50A-3P BREAKER IN PANEL LP14 WITH 3#6 & 1#10 GND IN 1" CONDUIT.
- 4 NEW 60A COMBINATION DISCONNECT SWITCH/CONTACTOR IN NEMA-4X STAINLESS ENCLOSURE WITH 50A FUSES AND HAND-OFF-AUTO SWITCH MOUNTED ON EXTERIOR OF CONTROLLER. FEED FROM NEW TRANSFORMER WITH 3#6 & 1#10 GND IN 1" CONDUIT. EXTEND AND CONNECT EXISTING SIGHT LIGHTING FEEDERS TO LOAD SIDE OF CONTACTOR.



NOTE:

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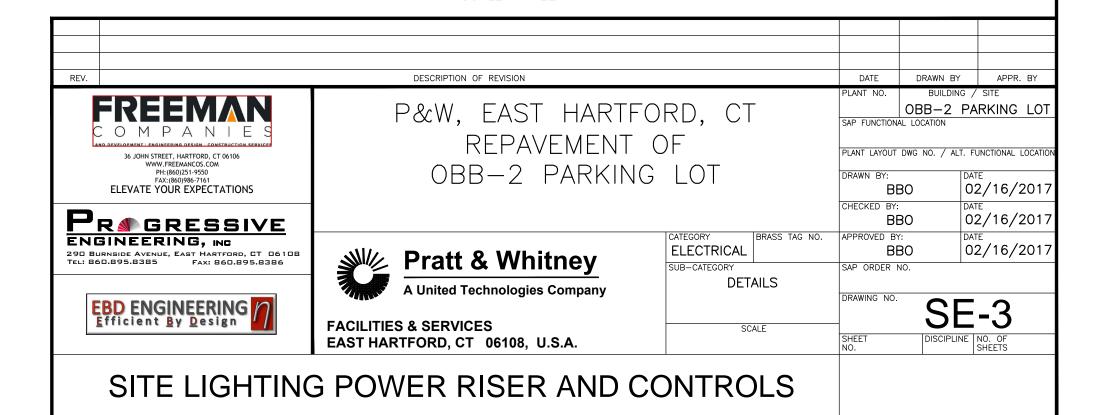
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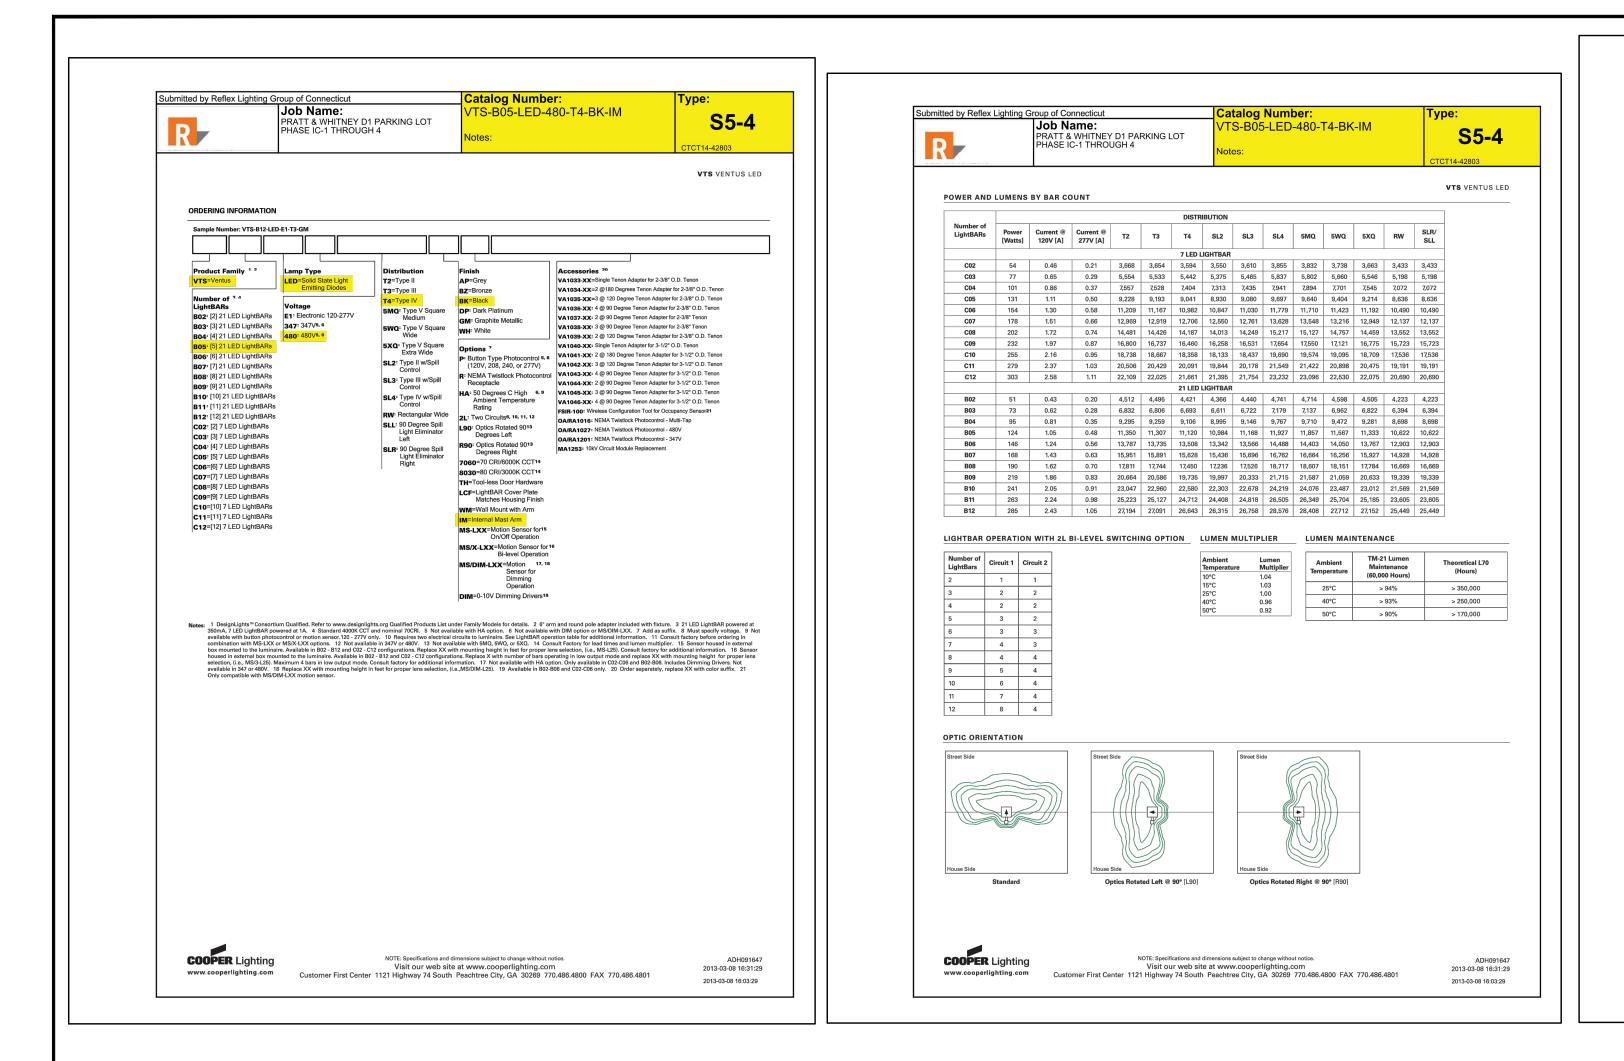
THE DEVELOPER SHALL NOTIFY THE TOWN OF EAST HARTFORD ENGINEERING DIVISION 24 HOURS PRIOR TO BEGINNING ANY STORM DRAINAGE, ROADWAY PREPARATION, PAVING, SIDEWALK, CURBING, STREET LINE MONUMENTATION, PROPERTY CORNER PINS, ETC., TO SCHEDULE INSPECTIONS. THE DIVISION CAN BE REACHED BETWEEN 8: 30 A.M. – 4: 30 P.M. AT (860)291–7380.


> TOWN OF EAST HARTFORD Planning and zoning commission site plan certificate of approval

EXPIRATION DATE



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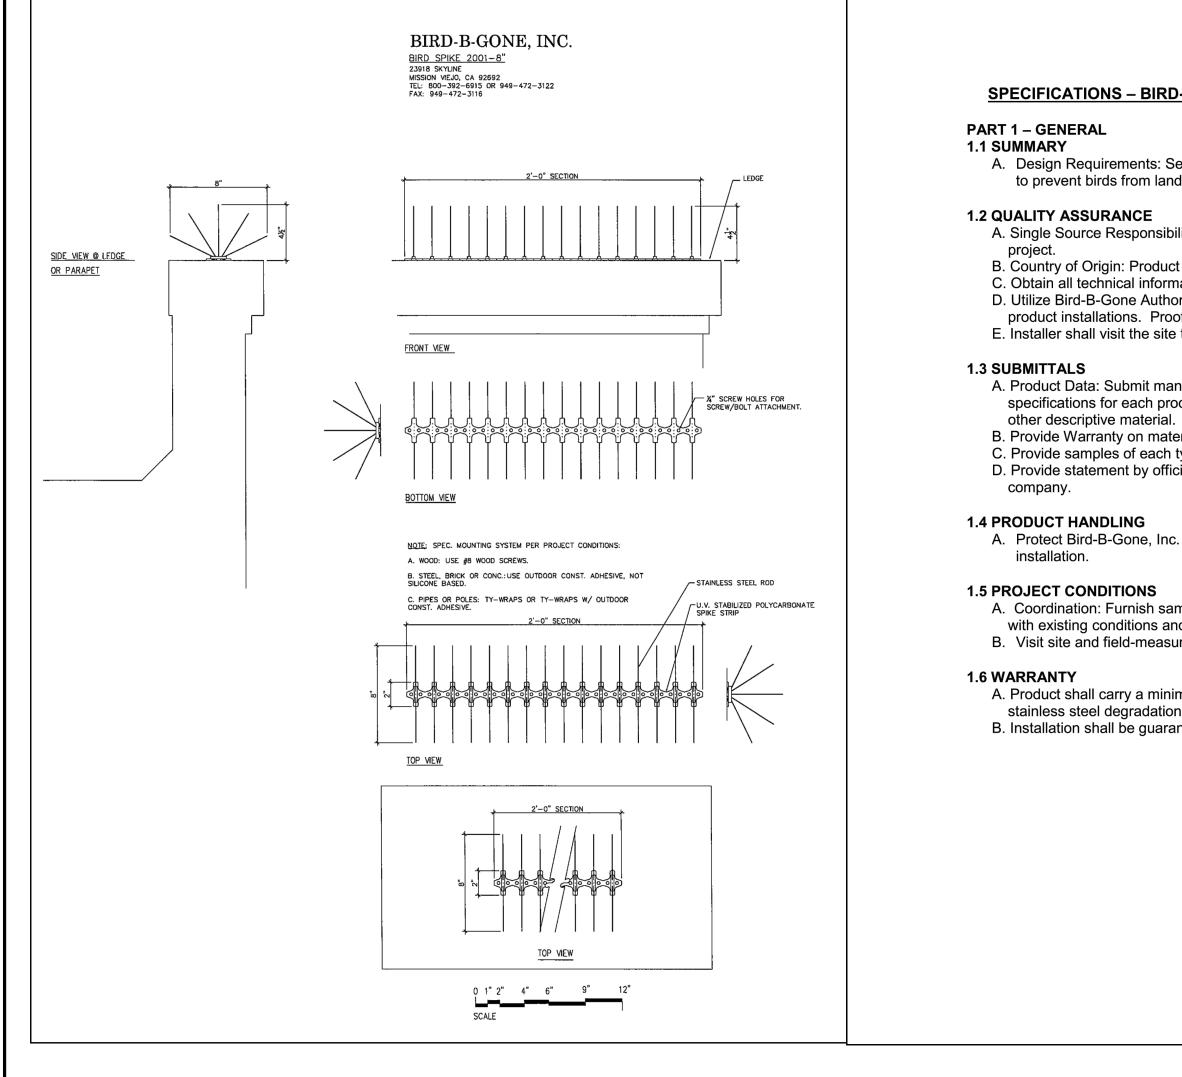


FACILITIES & SERVICES EAST HARTFORD, CT 06108, U.S.A.

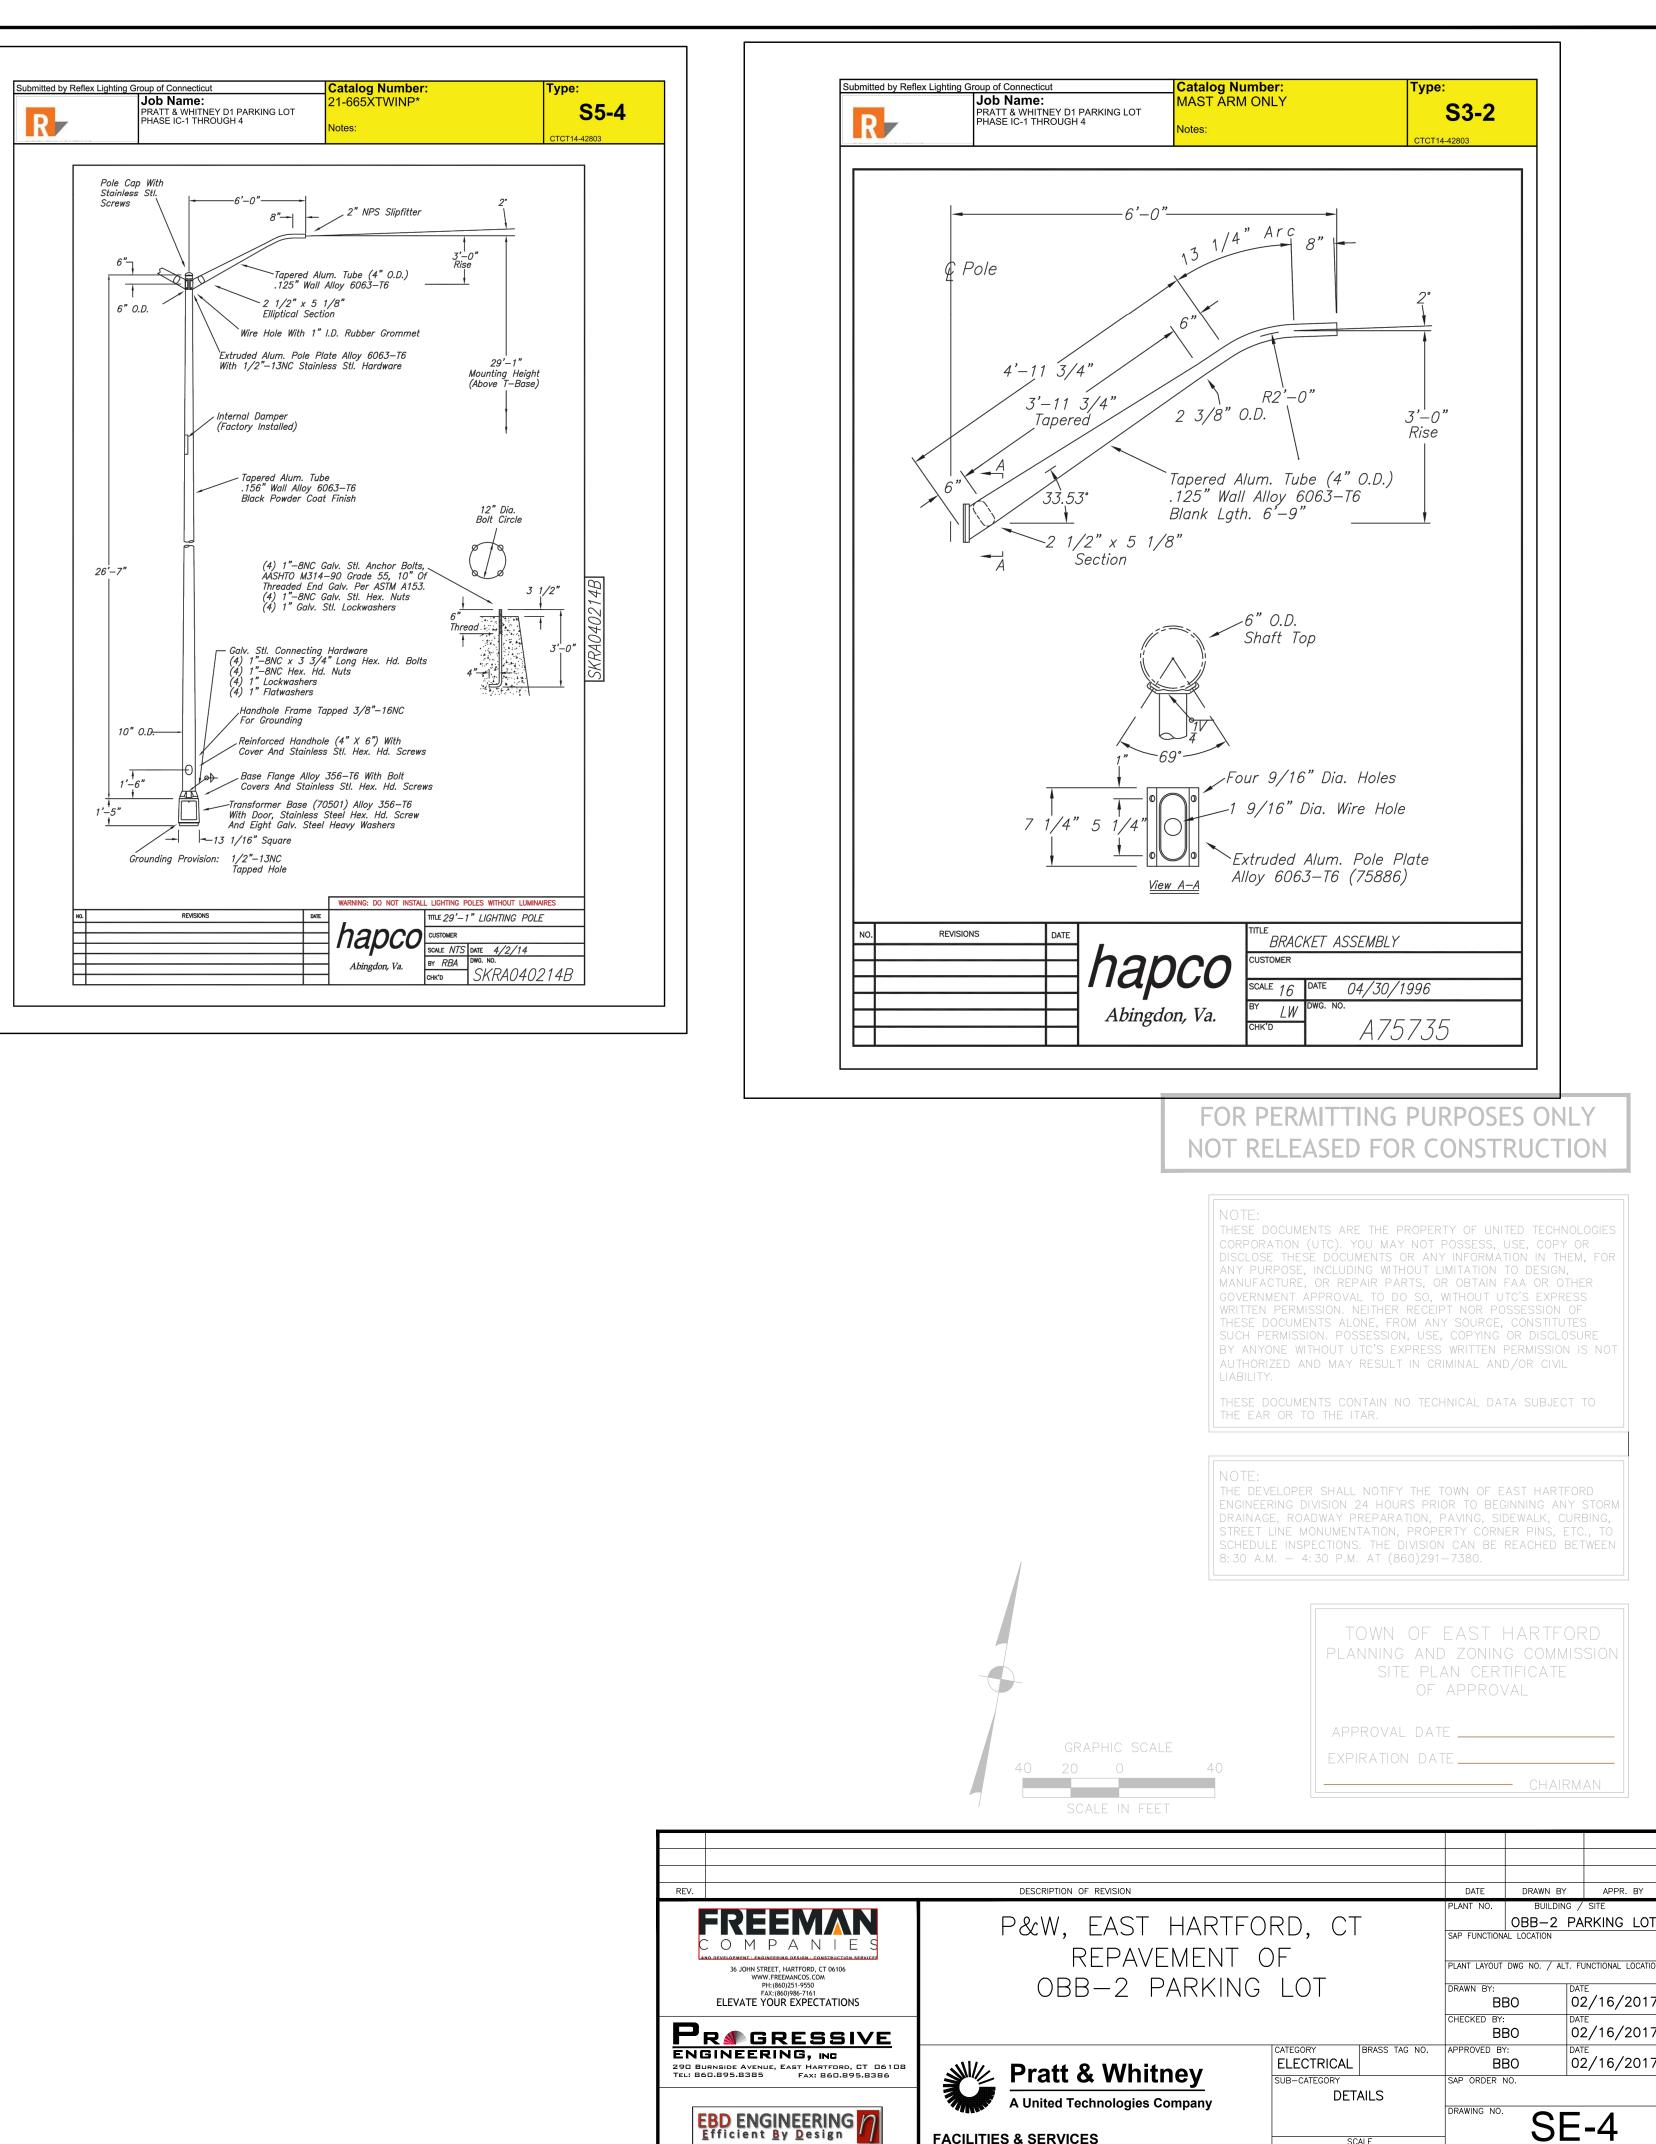SITE LIGHTING ELECTRICAL DETAILS

SCALE

SE-4 DISCIPLINE NO. OF SHEETS



SPECIFICATIONS – BIRD-B-GONE STAINLESS STEEL BIRD SPIKES™

A. Design Requirements: Select appropriate size as determined by site conditions to prevent birds from landing and roosting on specified surfaces.

A. Single Source Responsibility: Furnish products from one manufacturer for entire

B. Country of Origin: Product must be manufactured in the U.S.A. C. Obtain all technical information from the manufacturer. D. Utilize Bird-B-Gone Authorized Installers who are certified in Bird-B-Gone, Inc. product installations. Proof of Certification required. E. Installer shall visit the site to gather all information on existing site conditions.

A. Product Data: Submit manufacturer's descriptive literature and product specifications for each product including catalogs, installation instructions and

B. Provide Warranty on material and installation.

C. Provide samples of each type of spike excluding proposed fastening methods. D. Provide statement by official indicating that they are a certified installation

A. Protect Bird-B-Gone, Inc. products from damage before, during and after the

A. Coordination: Furnish samples of system(s) so installation can be coordinated with existing conditions and within on-site conditions. B. Visit site and field-measure prior to fabrication and delivery of materials.

A. Product shall carry a minimum 10 year guarantee against U.V. breakdown and stainless steel degradation. B. Installation shall be guaranteed for 2 years.

PART 2 – PRODUCTS 2.1 ACCEPTABLE MANUFACTURER

Manufacturer: Bird-B-Gone, Inc.

- Bird Spike 2001 Stainless Steel
- 23918 Skyline
- Mission Viejo, CA 92692 Tel: 800-392-6915 or 949-472-3122
- Fax: 949-472-3116 P.O.C.: Bruce Donoho

2.2 PRODUCT DESCRIPTION

- A. Model Designation:
 1. Bird-B-Gone Stainless Steel Bird Spikes[™] 1", 3", 5" or a
 - a. Width of Coverage:
 - i. BBG2001/1: 1" 2" widths
 - ii. BBG2001/3: 2" 4" widths
 - iii. BBG2001/5: 5" 7" widths
 - iv. BBG2001/8: 8" 10" widths b. Minimum 40 spikes per foot in linear array with "no gap and non-staggered design.
 - c. Height: 4-3/4"
 - d. Base Strip: Flexible. Base can bend up to 360°
 - e. Length: 2 ft. sections
 - f. Patented "Bend & Crush" technique anchors steel spike
 - unit.
 - g. Spike thickness must be .05 thousands/1.1 mm diame h. Packaging: 50 ft. per box. Twenty five (25) 2 ft. section
 - i. Number of Rows: As determined by the manufacturer a
 - project conditions.
- j. Mounting System: As determined by the manufacturer project conditions.
- B. Product made in the U.S.A.

2.3 MATERIALS

- A. Material: U.V. stabilized polycarbonate. Heat and weather resist to –200°F) marine grade 316 stainless steel spikes.
- B. Construction: Rigid one-piece construction.
 C. Adaptation: Tin snips, hacksaw, etc. can be used to cut / adapt t
- desired length.


2.4 MOUNTING SYSTEMS

- A. Wood: Use #8 wood screws. For every 2 ft. section of Bird-B-G Steel Spikes[™], ten (10) #8 wood screws are required. B. Steel, Brick, Stone or Concrete: Use an outdoor construction a
- non-silicone based. Purchase from the manufacturer or call for adhesives. If mounting surface warrants, screw or bolt down B Stainless Steel Spikes[™] in conjunction with using the adhesive


	C. Pipes or Poles: Ty-Wrap	s can be used alone or in conjur	nction with an
	outdoor construction adh Ty-Wraps, purchase dire	nesive that is non-silicone based actly from the manufacturer or ca	. For U.V. protected
	products.	-	
	PART 3 – EXECUTION 3.1 EXAMINATION		
		area and note any detrimental or ting officer or inspector of the de	
		Ilation until conditions are correc	ted.
- 8"	3.2 SURFACE PREPARATION A. Surface should be thorou	l ughly cleaned and free of bird dr	oppinas, nestina
	materials, rust, peeling p		
		n, including overhanging foliage,	
ap" center spike	3.3 INSTALLATION		
	manufacturer.	ess Steel Spikes™ as recommer	-
kes into base	the entire depth of the surface		
eter.		d angles closely; cut or break aw ordance with manufacturer's reco	
ns per box. and based on	3.4 INSPECTION A. Visually inspect Bird-B-Go	one Stainless Steel Spikes™ for	any signs of poor
and based on		se screws, fasteners and un-rem	
		OF SPECIFICATIONS	
stant, (+310°F			
the product to			
the product to			
Gone Stainless			
adhesive that is			
Bird-B-Gone			
/e.			
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		THESE DOCUMENTS CONTAIN NO TE THE EAR OR TO THE ITAR.	CHNICAL DATA SUBJECT TO
	Т	NOTE: The developer shall notify the	
		ENGINEERING DIVISION 24 HOURS P DRAINAGE, ROADWAY PREPARATION, STREET LINE MONUMENTATION, PRO	PAVING, SIDEWALK, CURBING,
		SCHEDULE INSPECTIONS. THE DIVISIO 3:30 A.M 4:30 P.M. AT (860)29	
		TOWN OF	EAST HARTFORD
			ID ZONING COMMISSION
		OF	APPROVAL
	GRAPHIC SCALE		TE
	40 20 0 40	EXPIRATION D	CHAIRMAN
	SCALE IN FEET		
REV.	DESCRIPTION OF REVISION		DATE DRAWN BY APPR. BY
FREEMAN	P&W, EAST HAR	TFORD, CT	PLANT NO. BUILDING / SITE OBB-2 PARKING LOT
COMPANIES AND DEVELOPMENT LENGINEERING DESIGN LEONSTRUCTION SERVICES 36 JOHN STREET, HARTFORD, CT 06106	REPAVEMEN		SAP FUNCTIONAL LOCATION
30 JOHN STREET, FRANTORU, CT 00100 WWW, FREEMARCOS, COM PH: (860)251-9550 FAX: (860)986-7161 ELEVATE YOUR EXPECTATIONS	OBB-2 PARKI	NG LOT	DRAWN BY: DATE BBO 02/16/2017
			CHECKED BY: BBO 02/16/2017
ENGINEERING, INC 290 BURNSIDE AVENUE, EAST HARFORD, CT D61DB TEL: 860.895.8385 FAX: 860.895.8386	Pratt & Whitney	CATEGORY ELECTRICAL BRASS TAG NO.	APPROVED BY: DATE BBO 02/16/2017
	A United Technologies Company	SUB-CATEGORY DETAILS	SAP ORDER NO.
EBD ENGINEERING	FACILITIES & SERVICES	SCALE	_ SE-5
	EAST HARTFORD, CT 06108, U.S.A.		SHEET DISCIPLINE NO. OF NO. SHEETS

SITE LIGHTING ELECTRICAL DETAILS

SHEETS

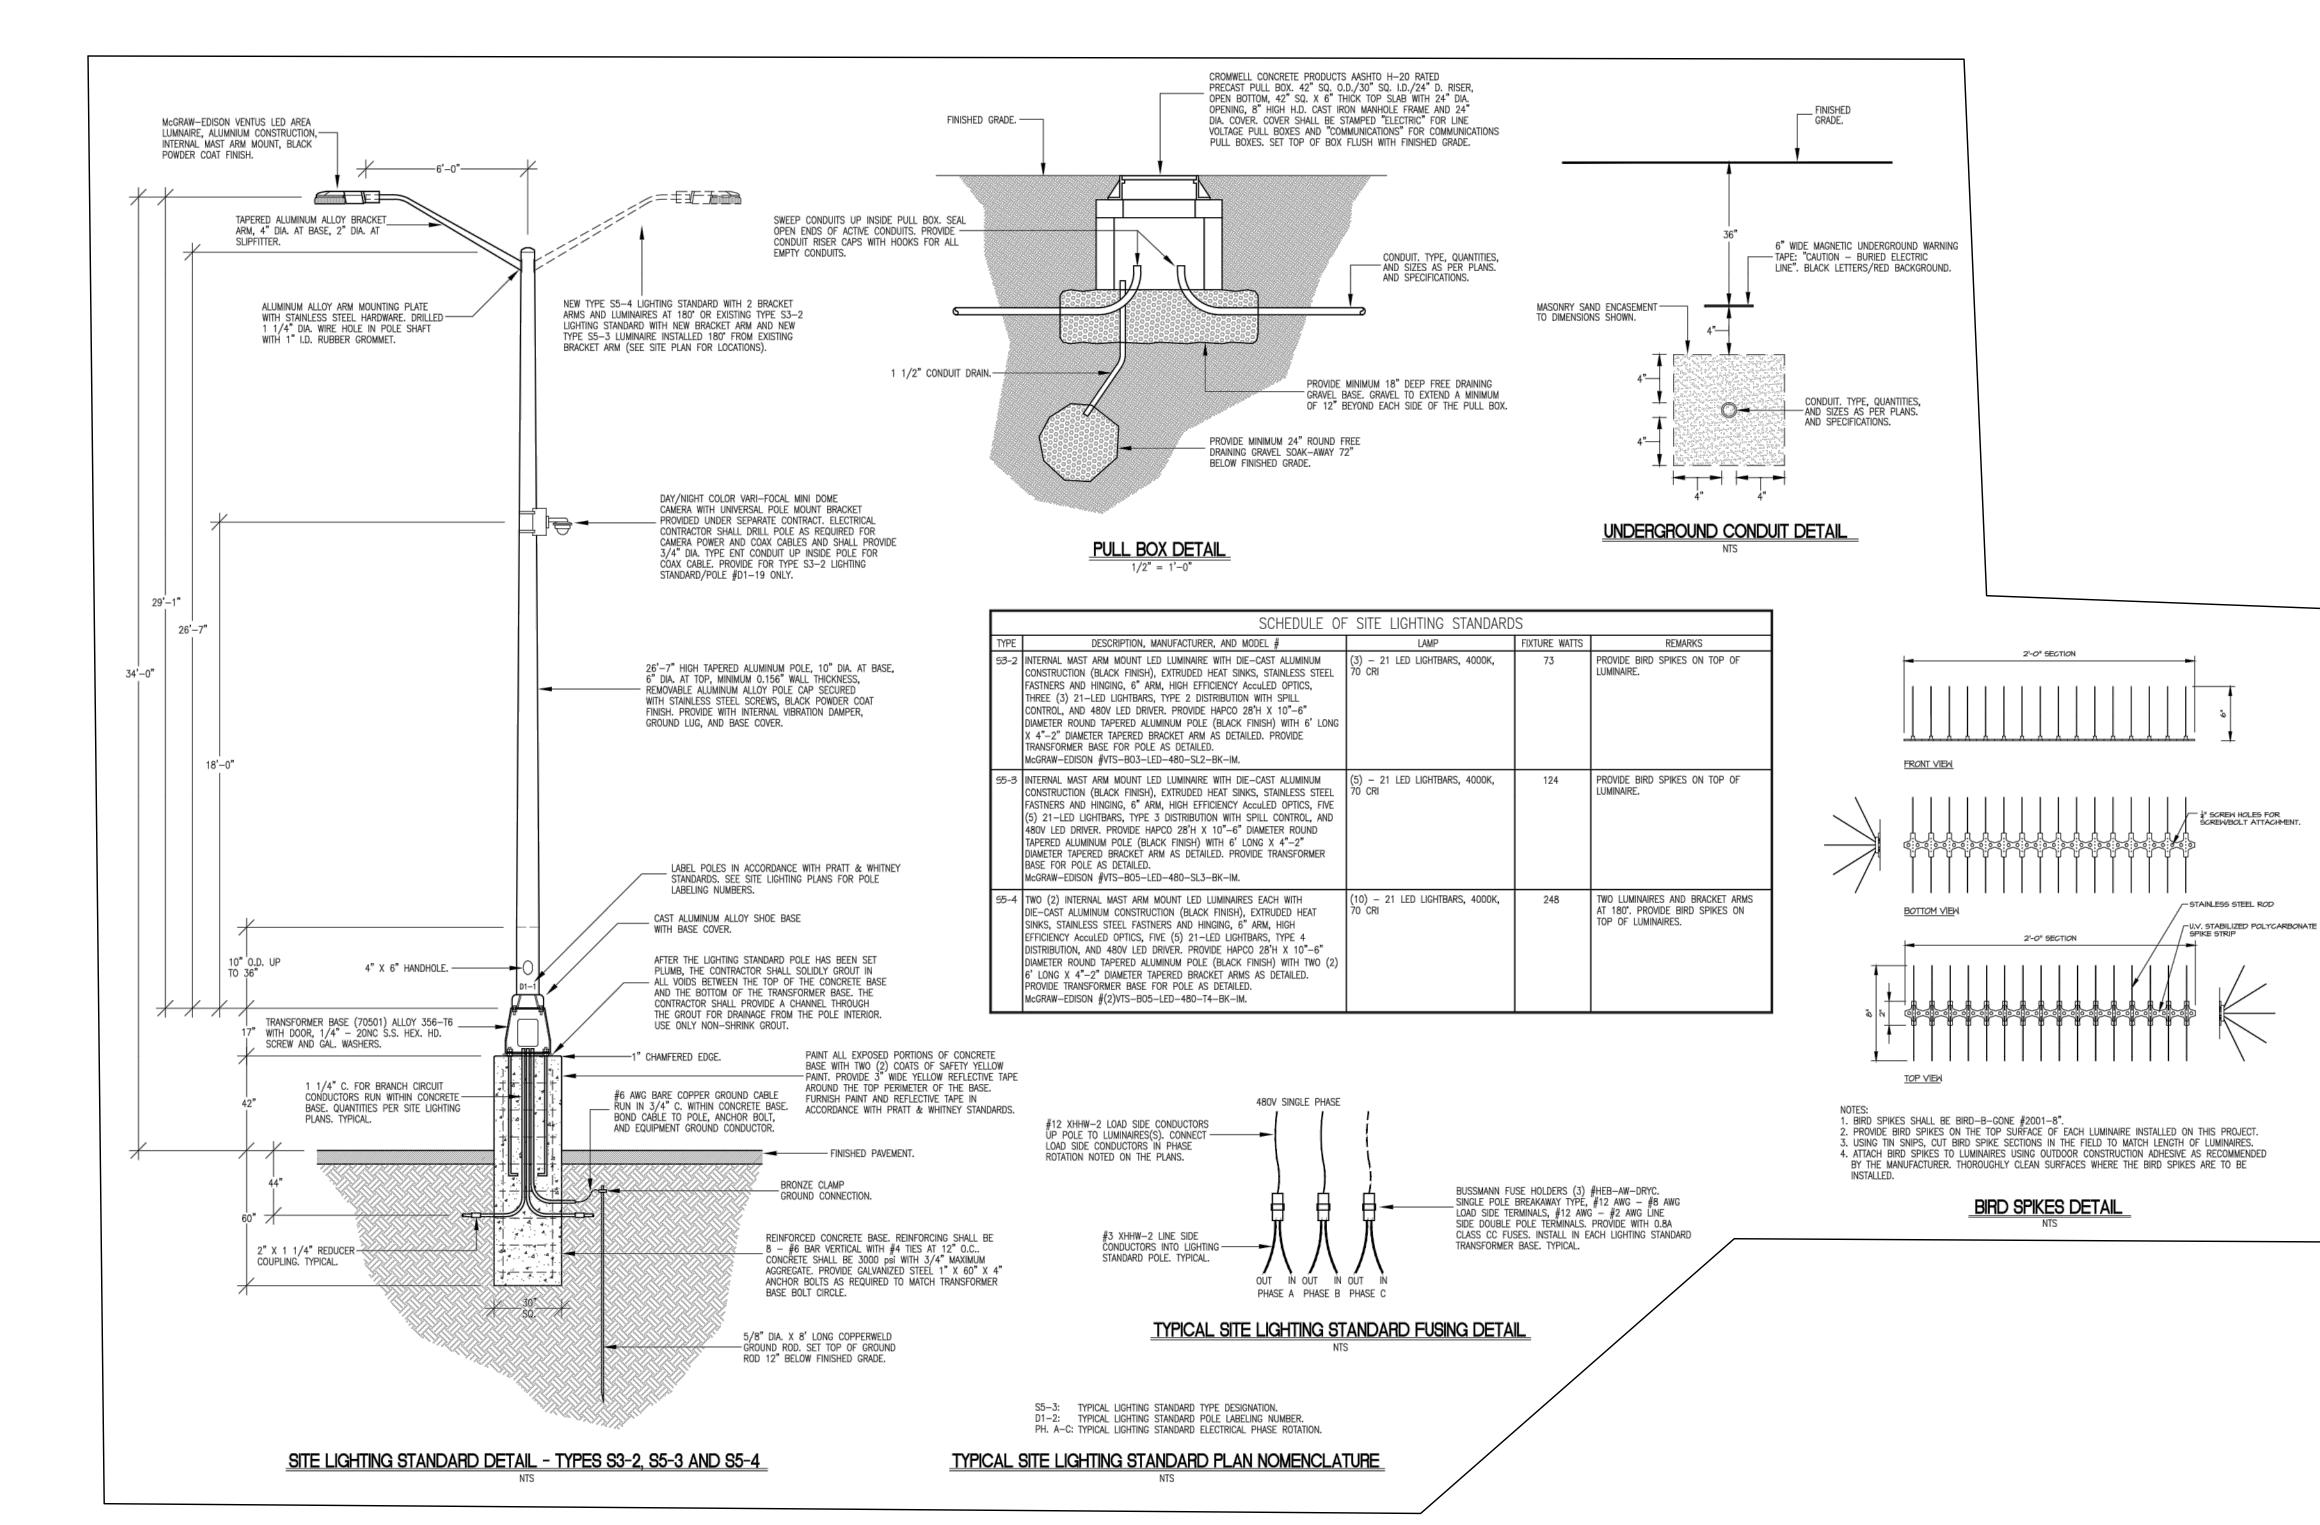

SCHEDULE OF SITE LIGHTING STANDARDS				
YPE	DESCRIPTION, MANUFACTURER, AND MODEL $\#$	LAMP	FIXTURE WATTS	REMARKS
3-2	INTERNAL MAST ARM MOUNT LED LUMINAIRE WITH DIE-CAST ALUMINUM CONSTRUCTION (BLACK FINISH), EXTRUDED HEAT SINKS, STAINLESS STEEL FASTNERS AND HINGING, 6" ARM, HIGH EFFICIENCY AccuLED OPTICS, THREE (3) 21-LED LIGHTBARS, TYPE 2 DISTRIBUTION WITH SPILL CONTROL, AND 480V LED DRIVER. PROVIDE HAPCO 28'H X 10"-6" DIAMETER ROUND TAPERED ALUMINUM POLE (BLACK FINISH) WITH 6' LONG X 4"-2" DIAMETER TAPERED BRACKET ARM AS DETAILED. PROVIDE TRANSFORMER BASE FOR POLE AS DETAILED. McGRAW-EDISON #VTS-B03-LED-480-SL2-BK-IM.	(3) — 21 LED LIGHTBARS, 4000K, 70 CRI	73	PROVIDE BIRD SPIKES ON TOP OF LUMINAIRE.
5-3	INTERNAL MAST ARM MOUNT LED LUMINAIRE WITH DIE-CAST ALUMINUM CONSTRUCTION (BLACK FINISH), EXTRUDED HEAT SINKS, STAINLESS STEEL FASTNERS AND HINGING, 6" ARM, HIGH EFFICIENCY AccuLED OPTICS, FIVE (5) 21-LED LIGHTBARS, TYPE 3 DISTRIBUTION WITH SPILL CONTROL, AND 480V LED DRIVER. PROVIDE HAPCO 28'H X 10"-6" DIAMETER ROUND TAPERED ALUMINUM POLE (BLACK FINISH) WITH 6' LONG X 4"-2" DIAMETER TAPERED BRACKET ARM AS DETAILED. PROVIDE TRANSFORMER BASE FOR POLE AS DETAILED. McGRAW-EDISON #VTS-B05-LED-480-SL3-BK-IM.	(5) — 21 LED LIGHTBARS, 4000K, 70 CRI	124	PROVIDE BIRD SPIKES ON TOP OF LUMINAIRE.
	TWO (2) INTERNAL MAST ARM MOUNT LED LUMINAIRES EACH WITH DIE-CAST ALUMINUM CONSTRUCTION (BLACK FINISH), EXTRUDED HEAT SINKS, STAINLESS STEEL FASTNERS AND HINGING, 6" ARM, HIGH EFFICIENCY AccuLED OPTICS, FIVE (5) 21-LED LIGHTBARS, TYPE 4 DISTRIBUTION, AND 480V LED DRIVER. PROVIDE HAPCO 28'H X 10"-6" DIAMETER ROUND TAPERED ALUMINUM POLE (BLACK FINISH) WITH TWO (2) 6' LONG X 4"-2" DIAMETER TAPERED BRACKET ARMS AS DETAILED. PROVIDE TRANSFORMER BASE FOR POLE AS DETAILED. MCGRAW-EDISON $\#(2)$ VTS-BO5-LED-480-T4-BK-IM.	(10) — 21 LED LIGHTBARS, 4000K, 70 CRI	248	TWO LUMINAIRES AND BRACKET ARMS AT 180°. PROVIDE BIRD SPIKES ON TOP OF LUMINAIRES.

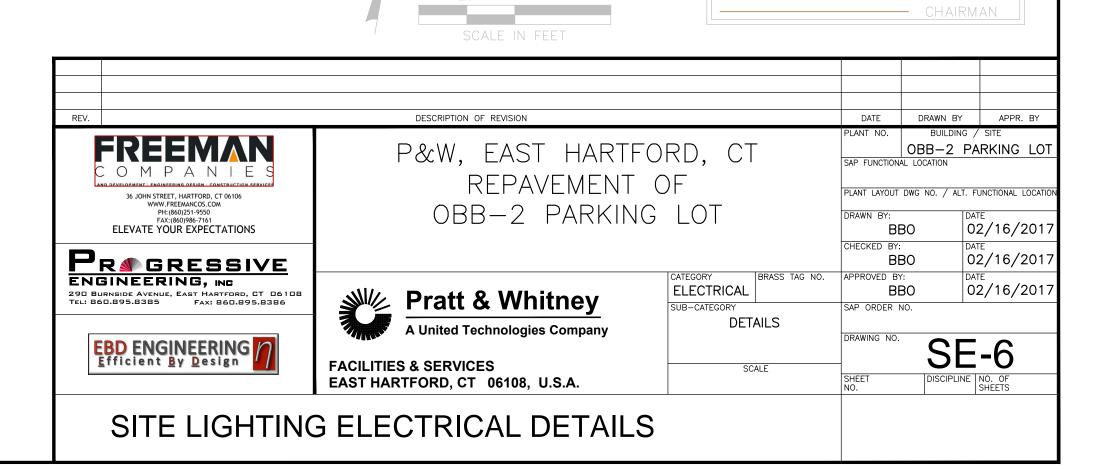



8:30 A.M. - 4:30 P.M. AT (860)291-7380.

BY ANYONE WITHOUT UTC'S EXPRESS WRITTEN PERMISSION IS NOT

FOR PERMITTING PURPOSES ONLY NOT RELEASED FOR CONSTRUCTION

ANY PURPOSE, INCLUDING WITHOUT LIMITATION TO DESIGN,

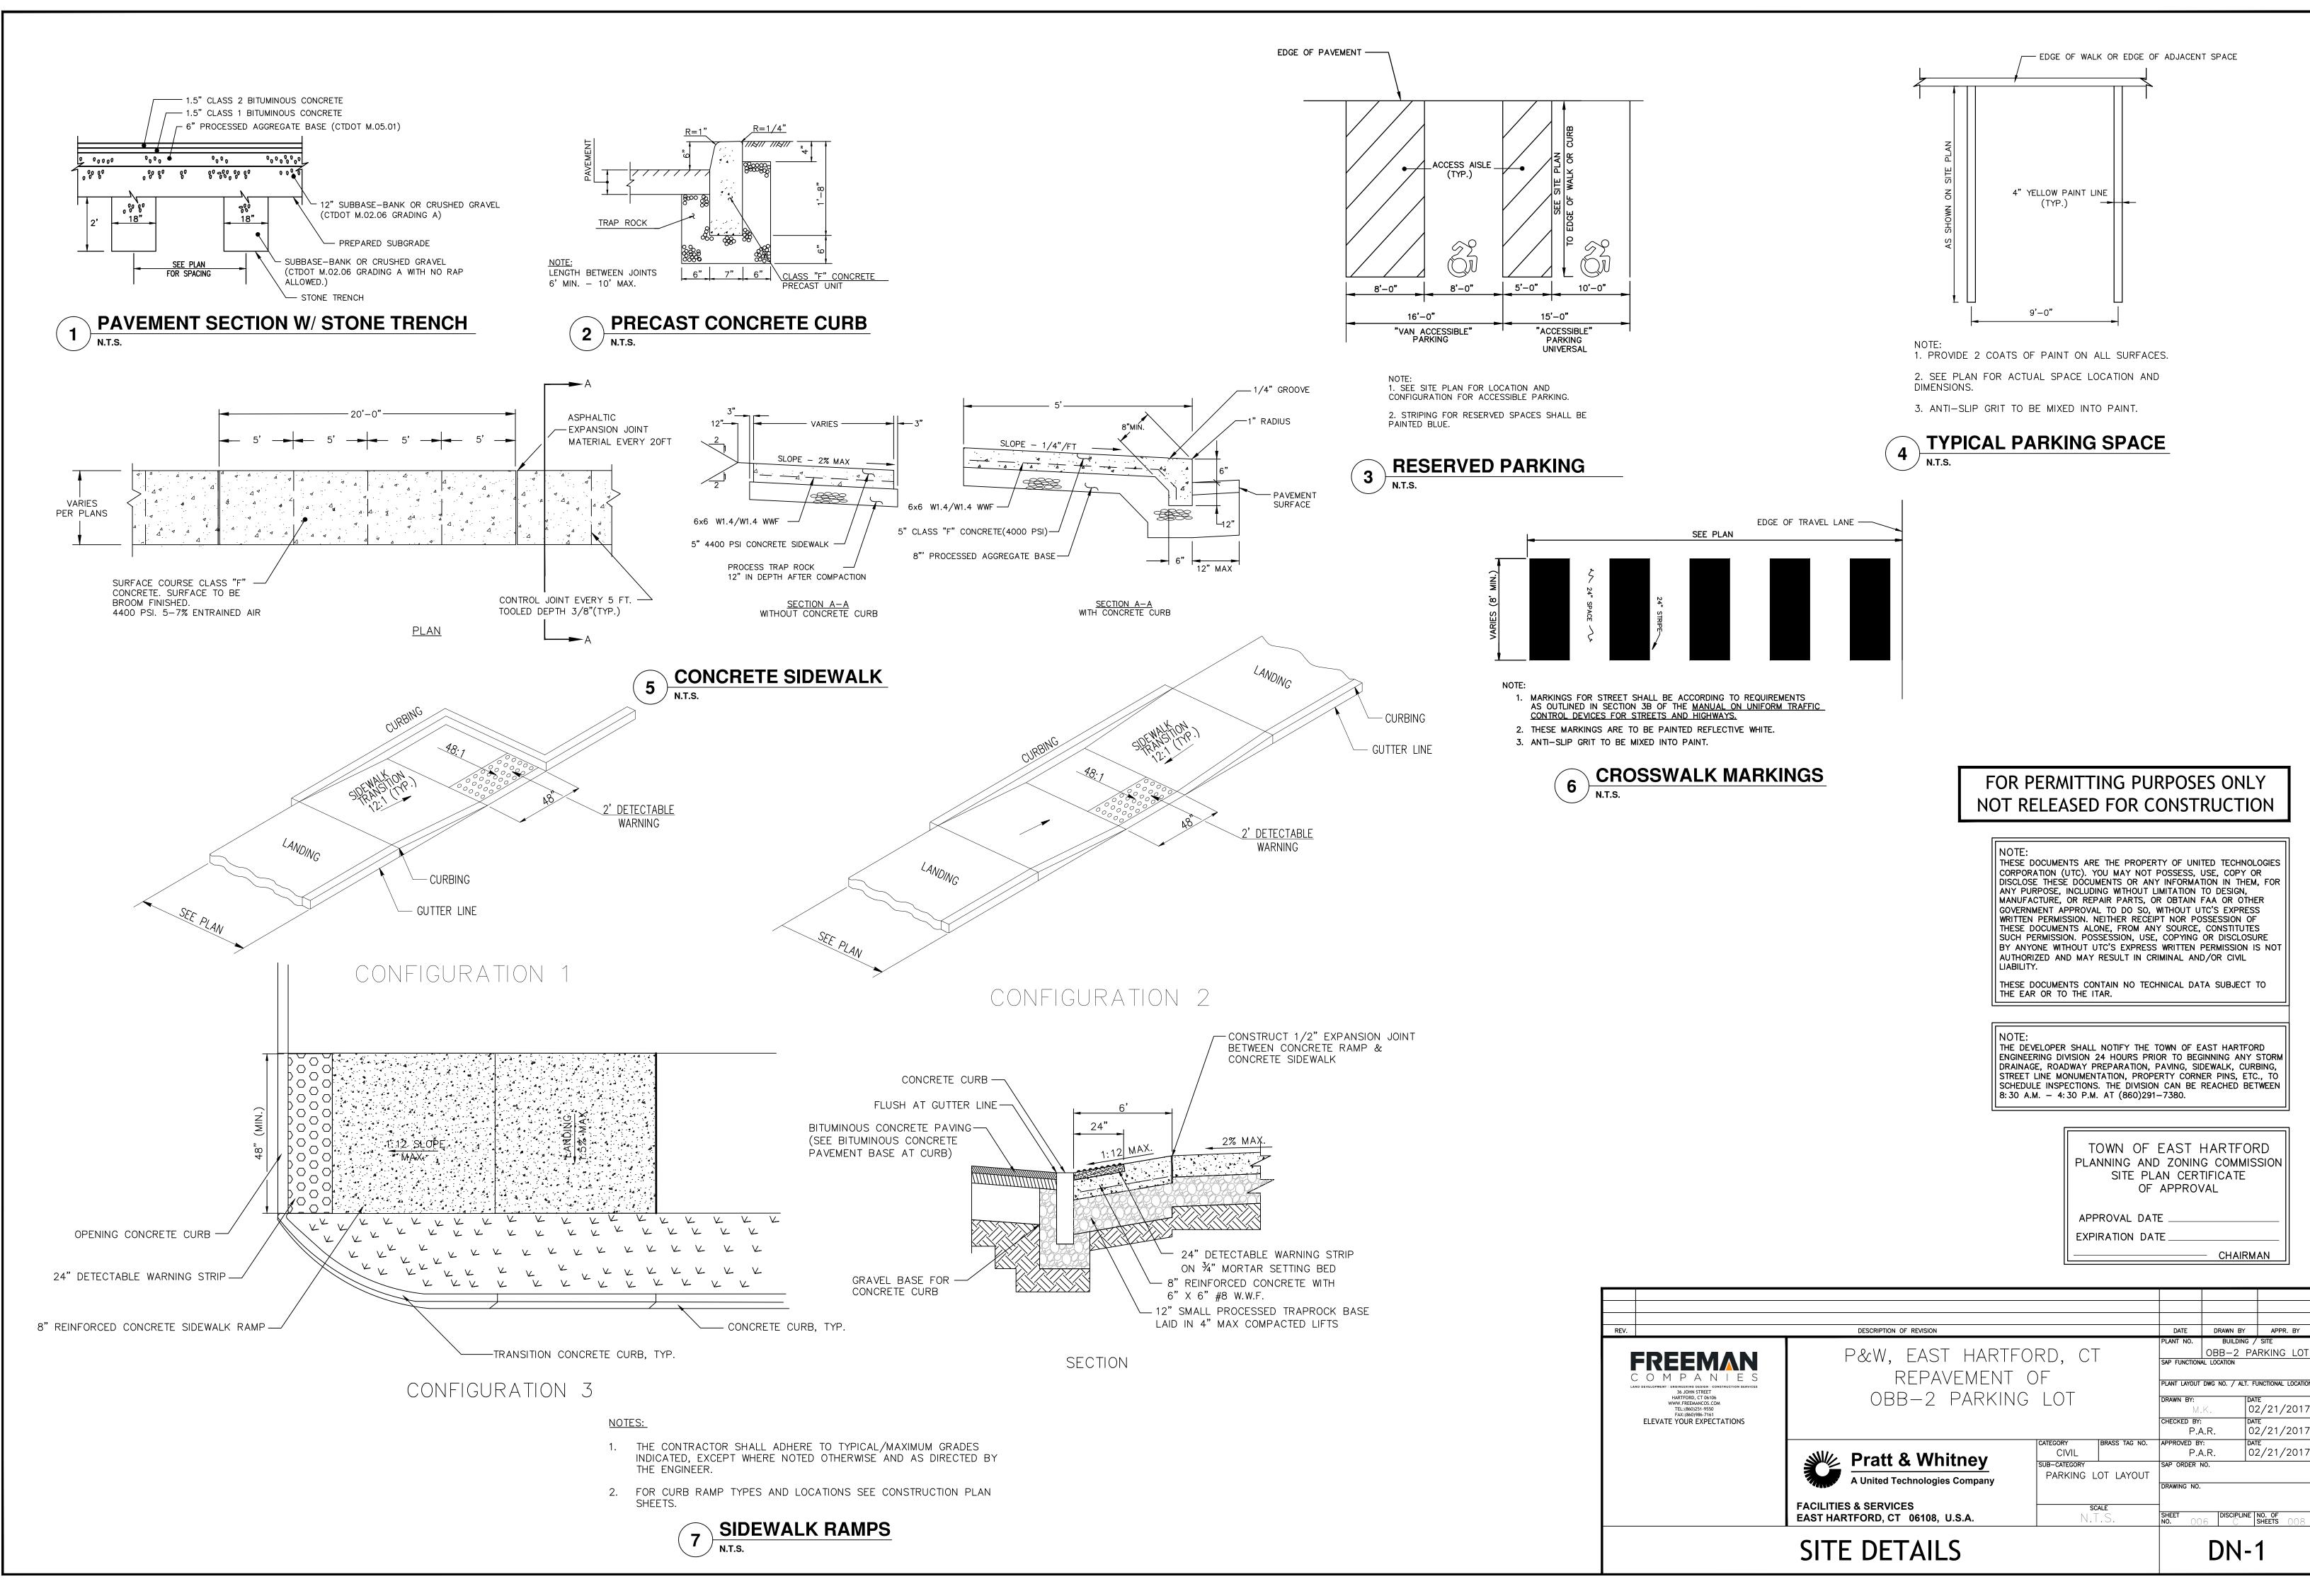

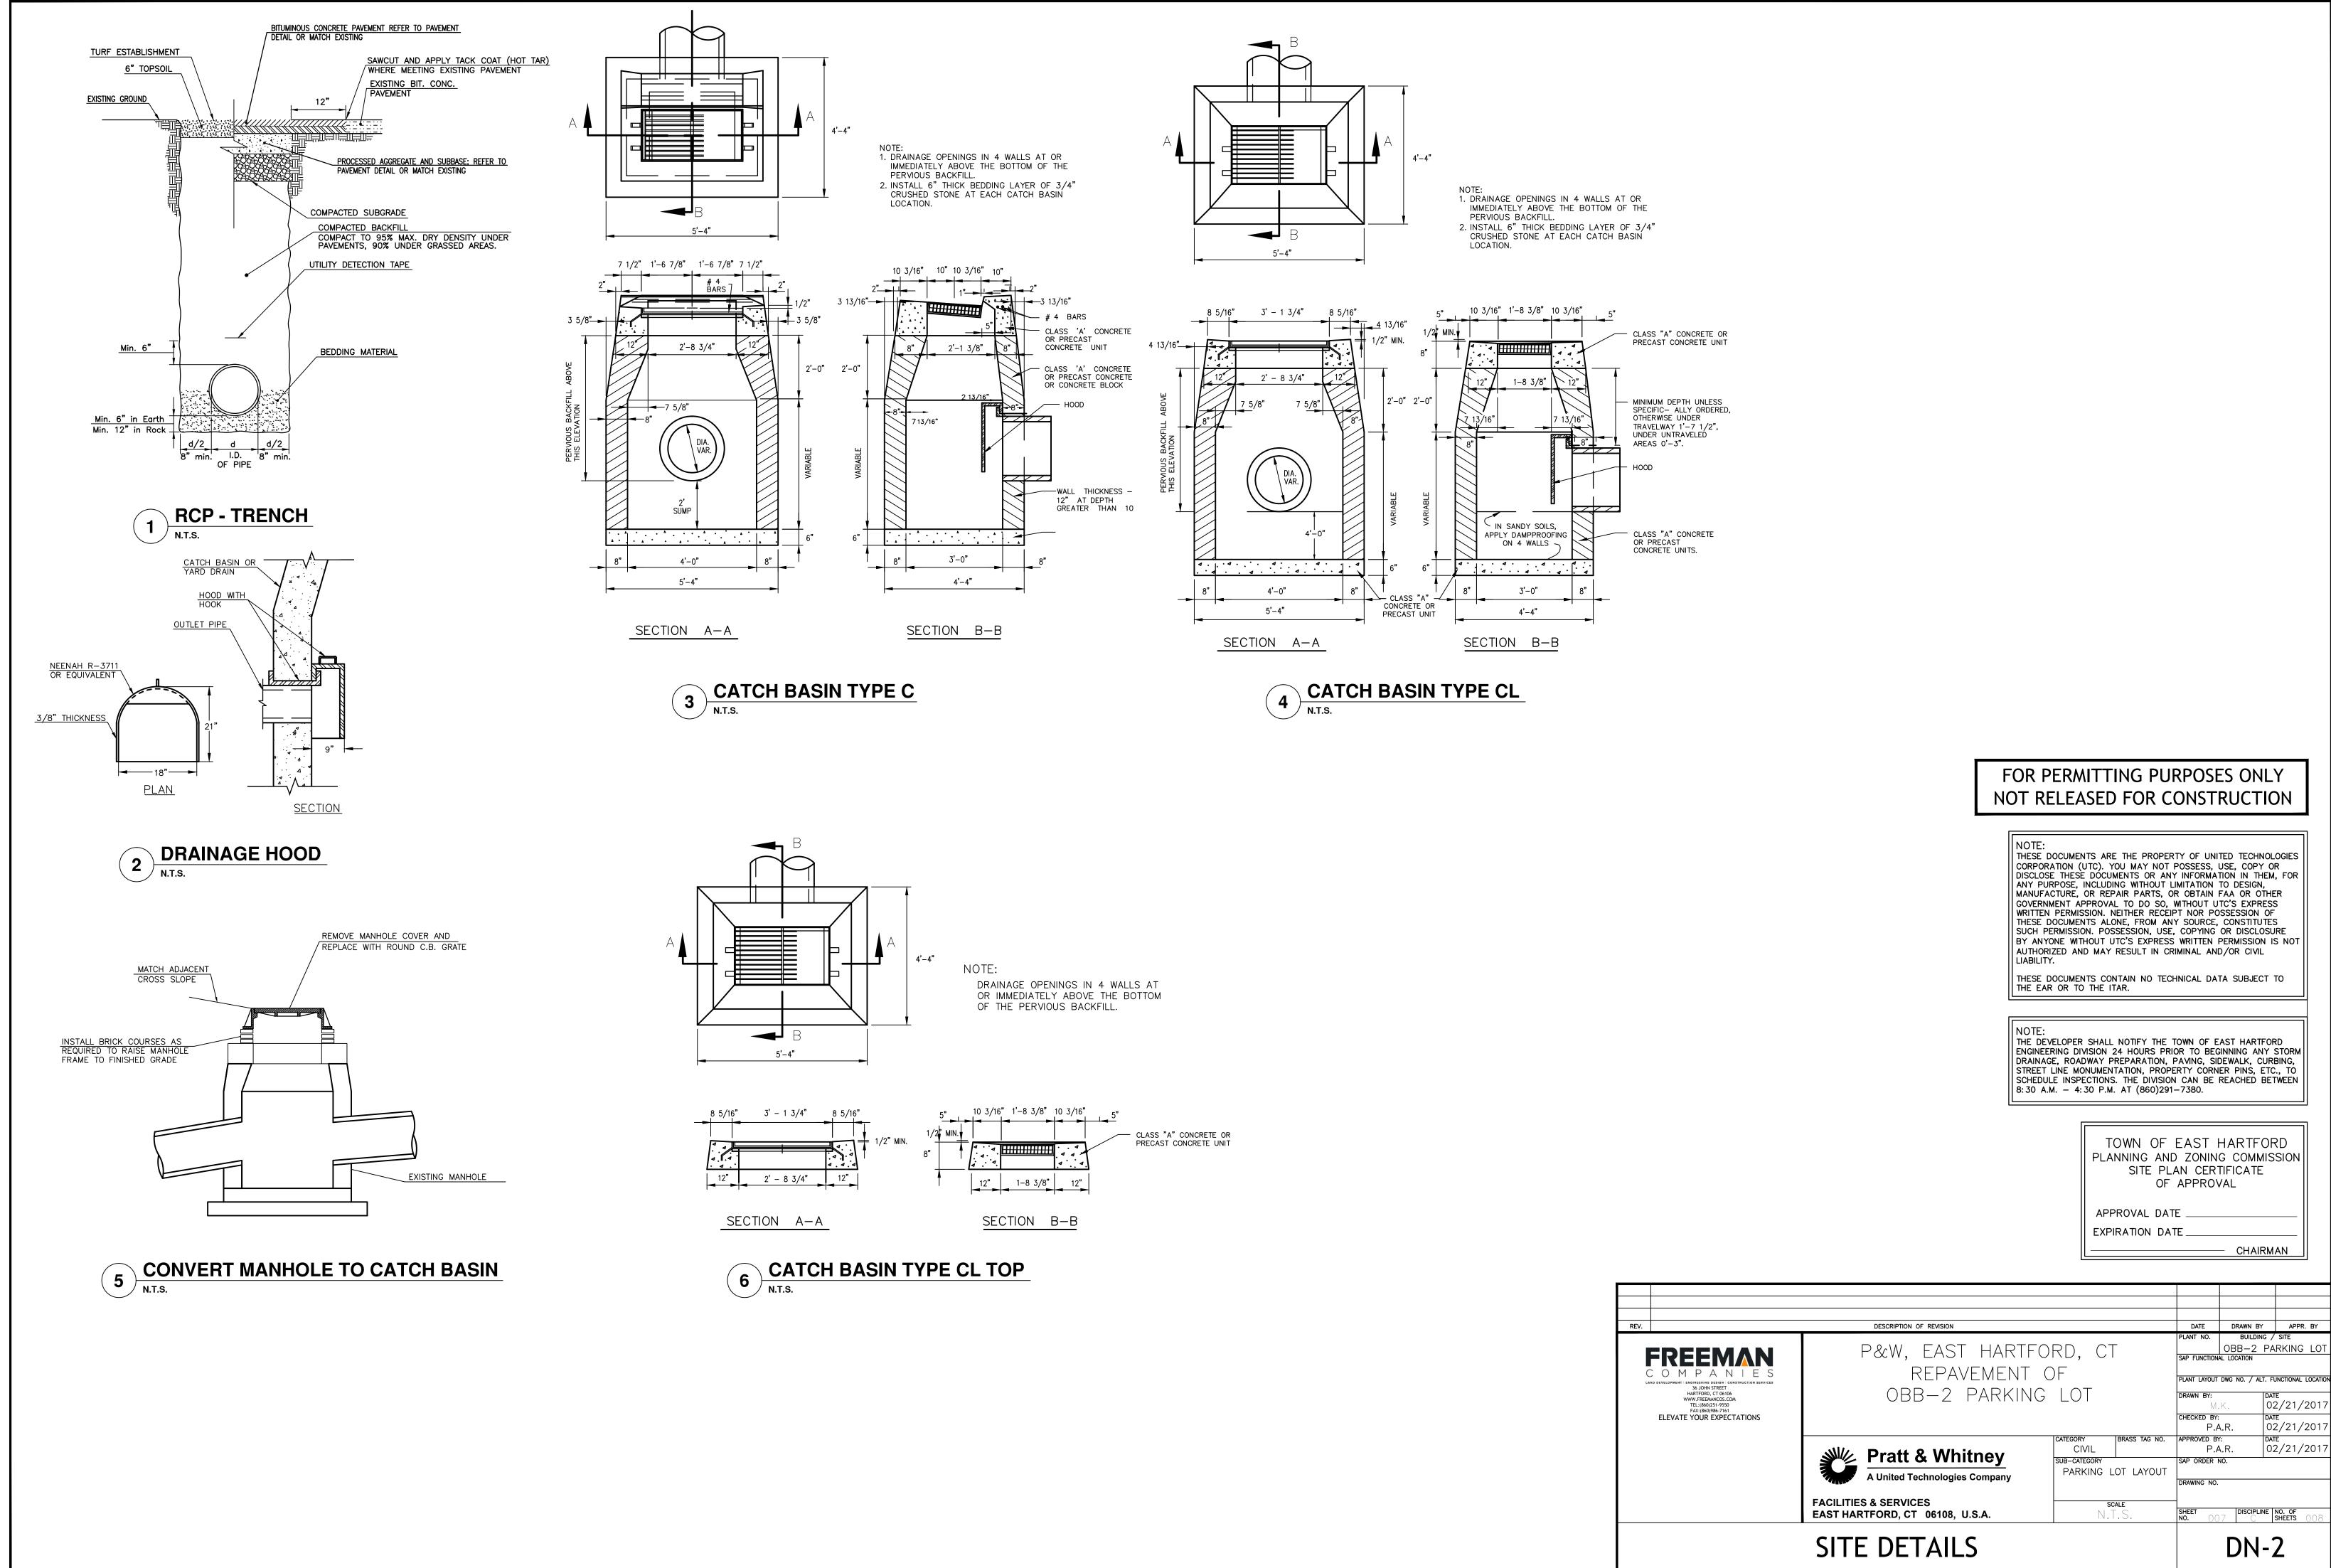

EROSION AND SEDIMENT CONTROL NARRATIVE FOR: REPAVEMENT OF OBB-2 PARKING LOT PRATT AND WHITNEY EAST HARTFORD, CONNECTICUT

. INTRODUCTION

THE EROSION AND SEDIMENT CONTROL PLAN HAS BEEN PREPARED AS PART OF THE CONSTRUCTION PLANS FOR THE REPAVEMENT OF OBB-2 PARKING LOT AT PRATT AND WHITNEY IN EAST HARTFORD, CONNECTICUT. INFORMATION RELATING TO SEDIMENTATION AND EROSION CONTROL IS INCLUDED IN THESE DRAWINGS. ALL SEDIMENTATION AND EROSION CONTROL ACTIVITIES SHALL BE IN COMPLIANCE WITH THE STORMWATER POLLUTION PREVENTION PLAN PREPARED FOR THIS PROJECT.

II. NARRATIVE

A. DESCRIPTION OF DEVELOPMENT

THE DEVELOPMENT SITE ENCOMPASSES APPROXIMATELY 8.13 ACRES LOCATED AT 400 MAIN ST EAST HARTFORD, CONNECTICUT. THE PROJECT INCLUDES A FULL DEPTH RECONSTRUCTION OF THE OBB-2 PARKING LOT. IT ALSO INCLUDES NEW CATCH BASINS, NEW CATCH BASIN TOPS, NEW LIGHTPOLES, AND NEW STRIPING.

B. CONSTRUCTION AND GRADING SCHEDULE

1. GENERAL

A. THE FOLLOWING SCHEDULE IS TO SERVE AS A GENERAL GUIDE TO THE SEQUENCE OF CONSTRUCTION ACTIVITIES FOR SEDIMENT AND EROSION CONTROL MEASURES. IT IS NOT INTENDED TO TAKE THE PLACE OF THE CONTRACTOR'S RESPONSIBILITY FOR DETAILED SCHEDULING OF ALL CONSTRUCTION ACTIVITIES. HOWEVER, THE SCHEDULE WILL BE INCORPORATED INTO THE CONTRACT DOCUMENTS AND NO SUBSTANTIAL DEVIATION FROM THIS SCHEDULE SHALL OCCUR WITHOUT PRIOR APPROVAL OF THE CONSTRUCTION MANAGER.

B. THE DATES GIVEN BELOW ARE APPROXIMATE TO GIVE AN INDICATION OF OVERALL CONSTRUCTION SEQUENCE.

START CONSTRUCTION	SPRING	2017
PARTIAL GRADING	SPRING	2017
FINAL GRADING	SUMMER	2017
END CONSTRUCTION	SUMMER	2017

THE CONTRACTOR IS REQUIRED TO MEET THE DATES AND DEADLINES ESTABLISHED IN THEIR CONTRACT EXECUTED WITH THE OWNER.

2. CONSTRUCTION SEQUENCE

THERE ARE THREE MAJOR PHASES OF CONSTRUCTION. EACH PHASE WILL INCLUDE THE INSTALLATION OF EROSION AND SEDIMENT (E&S) CONTROLS WHICH WILL NEED TO BE ADJUSTED AS THE PHASE EVOLVES AND AS DIRECTED BY THE ENGINEER. THE E&S CONTROLS WILL NEED TO BE INSPECTED DURING THE START OF EACH PHASE AND ADJUSTED OR REPLACED AS NEEDED. THE FOLLOWING ARE THE PROJECT PHASES;

1. DEMOLITION (SITE PREP) PHASE 2. MAJOR EARTHWORK AND UTILITY PHASE

3. SITE IMPROVEMENTS PHASE

A. CLEARING AND GRUBBING

(1.) CLEAR ALL TREES AND APPURTENANCES WITHIN THE PROPOSED PROJECT AREA THAT ARE NOT DESIGNATED TO REMAIN. CONTRACTOR SHALL VERIFY WITH THE ENGINEER REMOVAL OF ALL TREES. DISPOSE OF CLEARED ITEMS AT AN APPROVED OFF-SITE DISPOSAL AREA. (2.)CLEAN ALL EXISTING DRAINAGE STRUCTURES THAT ARE CURRENTLY FILLED.

B. EROSION AND SEDIMENT CONTROL

(1.)INSTALL HAYBALES, SILT FENCE, AND SILT SACKS AS SHOWN ON THE DRAWINGS OR AS DIRECTED BY THE ENGINEER.

C. SITE EXCAVATION AND GRADING

(1.)STRIP AND STOCK TOPSOIL. INSTALL HAY BALES AND SILT FENCE AROUND STOCKPILE AS REQUIRED. (2.)RELOCATE OR INSTALL ADDITIONAL SILT FENCE OR HAY BALES TO FULLY ENCLOSE AND CONTROL ALL WORK AREAS AS DIRECTED BY THE ENGINEER. (3.) AS EXCAVATION PROGRESSES, PROVIDE TEMPORARY CHANNELS OR BERMS AS NECESSARY TO DIRECT SITE RUNOFF TO THE PROPOSED OR EXISTING DRAINAGE STRUCTURES AS DIRECTED BY THE ENGINEER. OWNER.

(4.)THE CONTRACTOR SHALL STOCKPILE ALL EXCESS EXCAVATED MATERIAL AT LOCATIONS SHOWN ON THE DRAWINGS OR AS DIRECTED BY THE ENGINEER. HAYBALES SHALL BE PLACED AROUND THE PERIMETER OF ALL STOCKPILES. EXCESS MATERIAL WHICH WILL NOT BE REUSED SHALL BE TAKEN OFFSITE IMMEDIATELY. (5.)REPLACE CLOGGED SEDIMENTATION CONTROL BALES AS REQUIRED AND CLEAN SEDIMENT FROM BASINS WHEN ACCUMULATION SEDIMENT EXCEEDS 8" IN DEPTH.

E. ROUGH GRADING AND PAVING

SEDIMENT AND EROSION CONTROLS WITHIN THE PAVED AREAS SHALL BE LEFT IN PLACE UNTIL IMMEDIATELY BEFORE PAVING. MEASURES OUTSIDE OF THE PAVED AREA SHALL REMAIN UNTIL A STABLE VEGETATIVE GROWTH HAS BEEN ESTABLISHED ON ALL SLOPES OR UNTIL DIRECTED BY THE ENGINEER.

F. FINAL ITEMS

CLEAN ALL CATCH BASINS AND STORM MANHOLES OF ALL ACCUMULATED SEDIMENT AS DIRECTED BY THE ENGINEER.

CONTROL MEASURES

FAILED EROSION AND SEDIMENTATION CONTROL MEASURES WILL BE EVALUATED ON A CASE BY CASE BASIS BY THE ENGINEER AND APPROPRIATE MEASURES TAKEN. THESE MEASURES MAY INCLUDE CLEANING AND/OR REPLACEMENT OF DEFECTIVE FACILITIES OR INSTALLATION OF NEW OR SUPPLEMENTAL FACILITIES.

C. DESIGN CRITERIA

THE FOLLOWING DESIGN REFERENCES WERE FOLLOWED FOR THE PREPARATION OF STORM DRAINAGE DESIGN AND EROSION AND SEDIMENT CONTROL PLANS: 1. CONNECTICUT DOT DRAINAGE MANUAL

2. SCS GUIDELINE FOR SOIL EROSION AND SEDIMENT CONTROL SEDIMENTATION CONTROL BALES HAVE BEEN DESIGNED IN ACCORDANCE WITH CHAPTER 7, SECTION F OF THE CONNECTICUT GUIDELINES FOR SOIL EROSION AND SEDIMENT CONTROL

D. CONSTRUCTION DETAILS

CONSTRUCTION DETAILS FOR THE PROPOSED PROJECT ARE PRESENTED ON THE DETAIL SHEETS.

E. INSTALLATION PROCEDURES

THE INSTALLATION PROCEDURES FOR STORMWATER MANAGEMENT FACILITIES AND EROSION AND SEDIMENTATION CONTROL MEASURES ARE PRESENTED IN THE PROJECTS TECHNICAL SPECIFICATIONS FOR DRAINAGE; EXCAVATION, FILLING AND GRADING; AND SEDIMENTATION AND EROSION CONTROL. ADDITIONAL INSTALLATION PROCEDURES ARE SHOWN ON THE CONSTRUCTION DETAILS BOTH VISUALLY AND BY USE OF CONSTRUCTION NOTES.

F. OPERATION AND MAINTENANCE


1. DURING CONSTRUCTION

BEST MANAGEMENT PRACTICES, SHALL BE UTILIZED TO CONTROL STORM WATER DISCHARGES AND TO PREVENT EROSION AND SEDIMENTATION AND TO OTHERWISE PREVENT POLLUTION OF WETLANDS OR WATERCOURSES. FOR INFORMATION AND TECHNICAL ASSISTANCE, CONTACT THE CITY ENGINEER. THE PERMITTEE SHALL IMMEDIATELY INFORM THE ENGINEERING DEPARTMENT OF ANY PROBLEMS INVOLVING WETLANDS OR WATERCOURSES WHICH HAVE DEVELOPED IN THE COURSE OF, OR WHICH ARE CAUSED BY, THE AUTHORIZED WORK. NO EQUIPMENT OR MATERIAL INCLUDING WITHOUT LIMITATION, FILL, CONSTRUCTION MATERIALS, OR DEBRIS, SHALL BE DEPOSITED, PLACED, OR STORED IN ANY WETLAND OR WATERCOURSE ON OR OFF SITE. TIMELY IMPLEMENTATION AND MAINTENANCE OF SEDIMENT AND EROSION CONTROL MEASURES ARE REQUIRED. ALL SEDIMENT AND EROSION CONTROL MEASURES MUST BE MAINTAINED UNTIL ALL DISTURBED AREAS ARE STABILIZED.


A PRE-CONSTRUCTION MEETING SHALL BE HELD PRIOR TO THE COMMENCEMENT OF ANY CONSTRUCTION ACTIVITIES ON THE SITE WITH THE CONTRACTOR, AND CITY STAFF. AS CONTAINED IN THE SEDIMENTATION AND EROSION CONTROL SPECIFICATIONS, OPERATIONS AND MAINTENANCE DURING CONSTRUCTION WILL CONSIST OF PERIODIC REPLACEMENT AND/OR CLEANING OF CLOGGED HAY BALES, SILT FENCE AND CONSTRUCTION ENTRANCE AT NO ADDITIONAL COST TO THE OWNER ANY TEMPORARY SEDIMENTATION BASINS WILL BE CLEANED OF ACCUMULATED. SEDIMENT WHEN THE DEPTH OF ACCUMULATED SEDIMENT EXCEEDS 8". ALL DRAINAGE STRUCTURES SHALL BE INSPECTED ON DAILY BASIS AND ANY NECESSARY CORRECTIVE ACTION TAKEN.

G. DESIGNATED ON-SITE AGENT

1. THE PERSON RESPONSIBLE FOR OVERSEEING OF PROPER INSTALLATION AND MAINTENANCE OF ALL SOIL EROSION SEDIMENT CONTROL MEASURES FOR THIS PROJECT SHALL BE THE SITE CONTRACTOR.

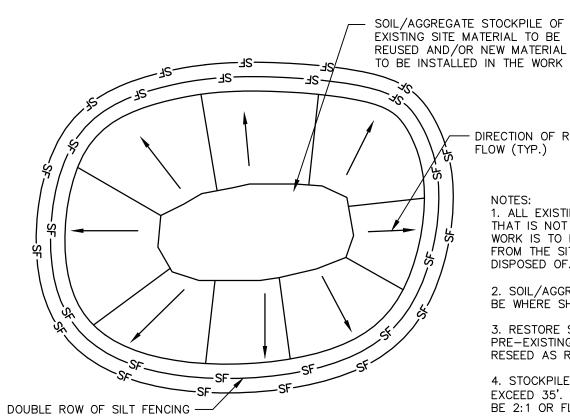



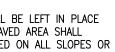


3. CONTINGENCY PLANS FOR FAILED EROSION AND SEDIMENTATION

DIRECTION OF RUN-OFF FLOW (TYP.)


NOTES: 1. ALL EXISTING EXCAVATED MATERIAL THAT IS NOT TO BE REUSED IN THE WORK IS TO BE IMMEDIATELY REMOVED FROM THE SITE AND PROPERLY DISPOSED OF.


2. SOIL/AGGREGATE STOCKPILE SITES TO BE WHÉRE SHOWN ON THE DRAWINGS. 3. RESTORE STOCKPILE SITES TO PRE-EXISTING PROJECT CONDITION AND

RESEED AS REQUIRED. 4. STOCKPILE HEIGHTS MUST NOT EXCEED 35'. STOCKPILE SLOPES MUST BE 2:1 OR FLATTER.

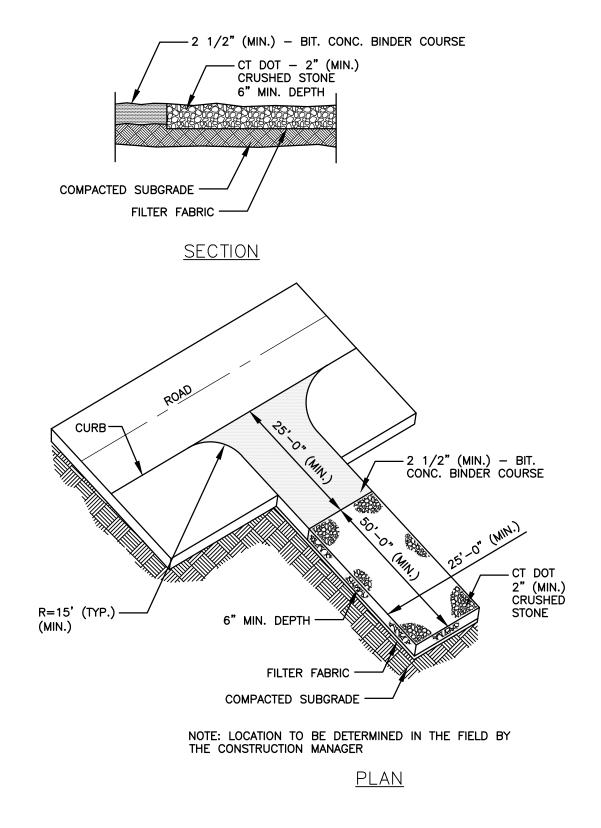

ANTI-TRACKING PAD N.T.S.

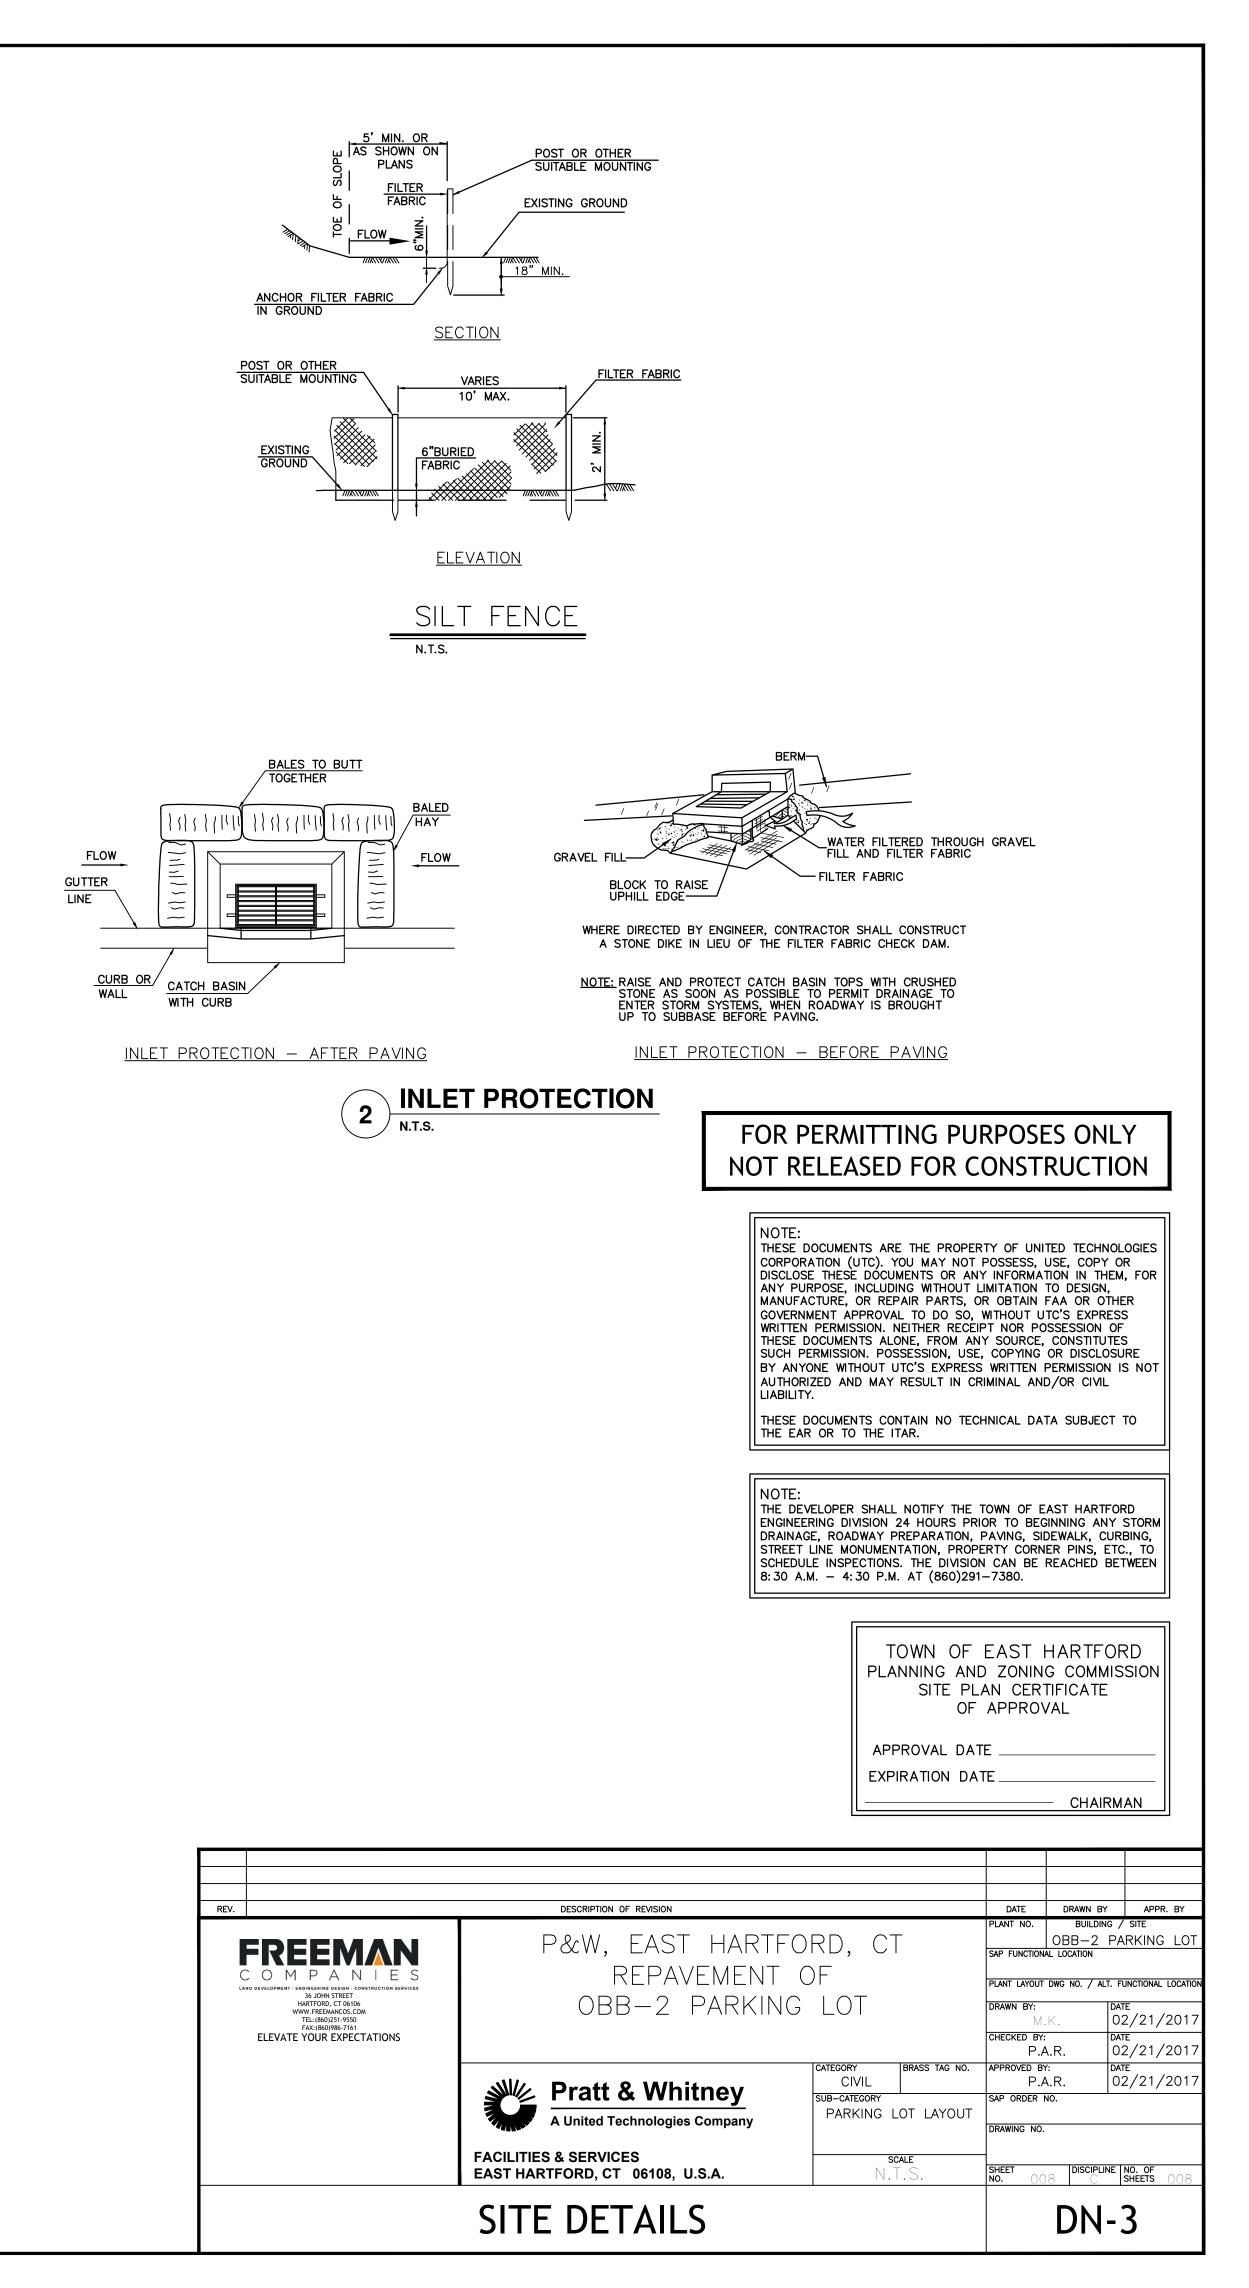

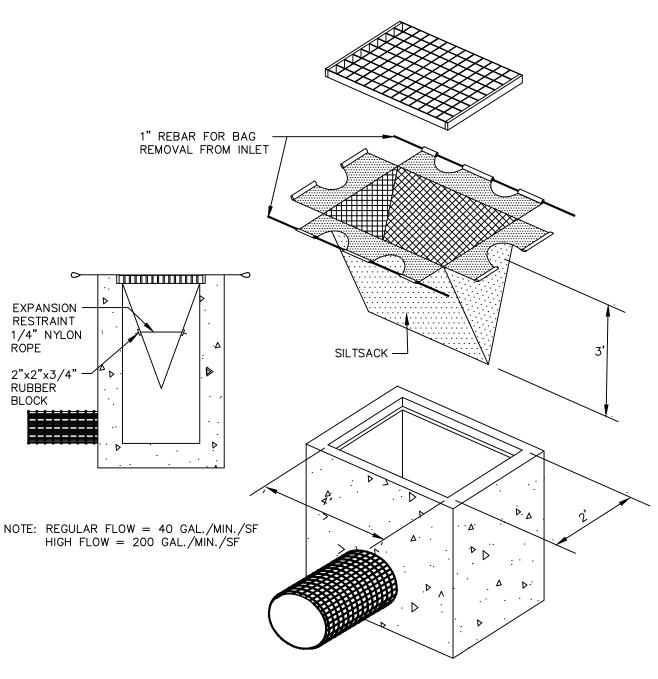

SILT SACK N.T.S.