
KIA OF EAST HARTFORD SITE MODIFICATION PLANS

99 ASH STREET, EAST HARTFORD, CONNECTICUT MAP 5, LOT 13

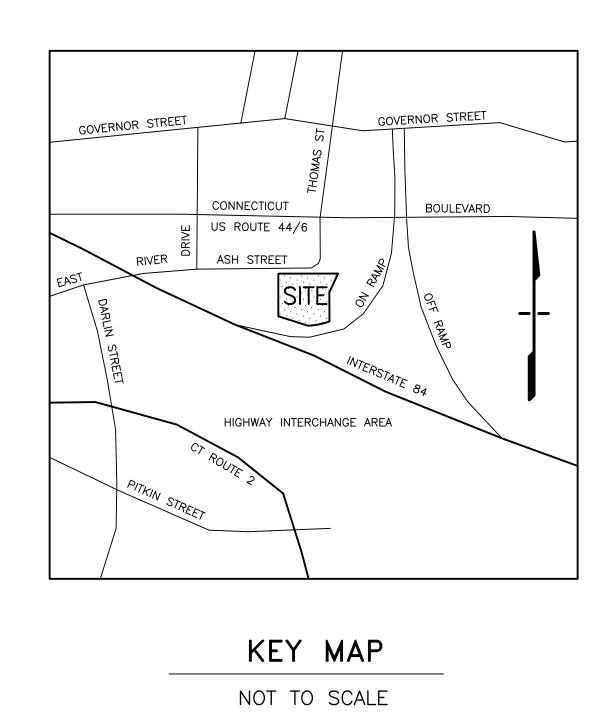

APPLICANT

ASH STREET HOLDINGS LLC 687 ASH SWAMP ROAD GLASTONBURY, CT 06033

OWNER

ASH REALTY ASSOCIATES, LLC 1659 CODY AVENUE RIDGEWOOD, NY 11385

ARCHITECT

DESIGN TWO ARCHITECTURE 188 LOVERS LANE GUILFORD, CT 06437 (203) 458-3956

LIST OF DRAWINGS

SHEET	DESCRIPTION
1	COVER SHEET
2	EXISTING CONDITIONS PLAN
3	PROPERTY/BOUNDARY SURVEY
4	SITE LAYOUT PLAN
5	GRADING AND UTILITIES WITH EROSION CONTROL PLAN
6	VEHICLE TURNING DIAGRAMS
7	SITE DETAILS
8	ARCHITECTURAL FIRST FLOOR PLAN (A1)
9	ARCHITECTURAL SECOND FLOOR PLAN (A2)
10	ARCHITECTURAL EXTERIOR ELEVATIONS (A3)

ENGINEERS/SURVEYORS



Meehan & Goodin Engineers — Surveyors, P.C. 387 North Main Street, Manchester, CT 06042 (860) 643-2520FAX (860) 649-8806


internet: www.meehangoodin.com

Date: November 2, 2017

TOWN OF EAST HARTFORD PLANNING AND ZONING COMMISSION SITE PLAN CERTIFICATE OF APPROVAL APPROVAL DATE:_____ EXPIRATION DATE:_____

_____ CHAIRMAN

MEEHAN & GOODIN PROJECT NO. 17113

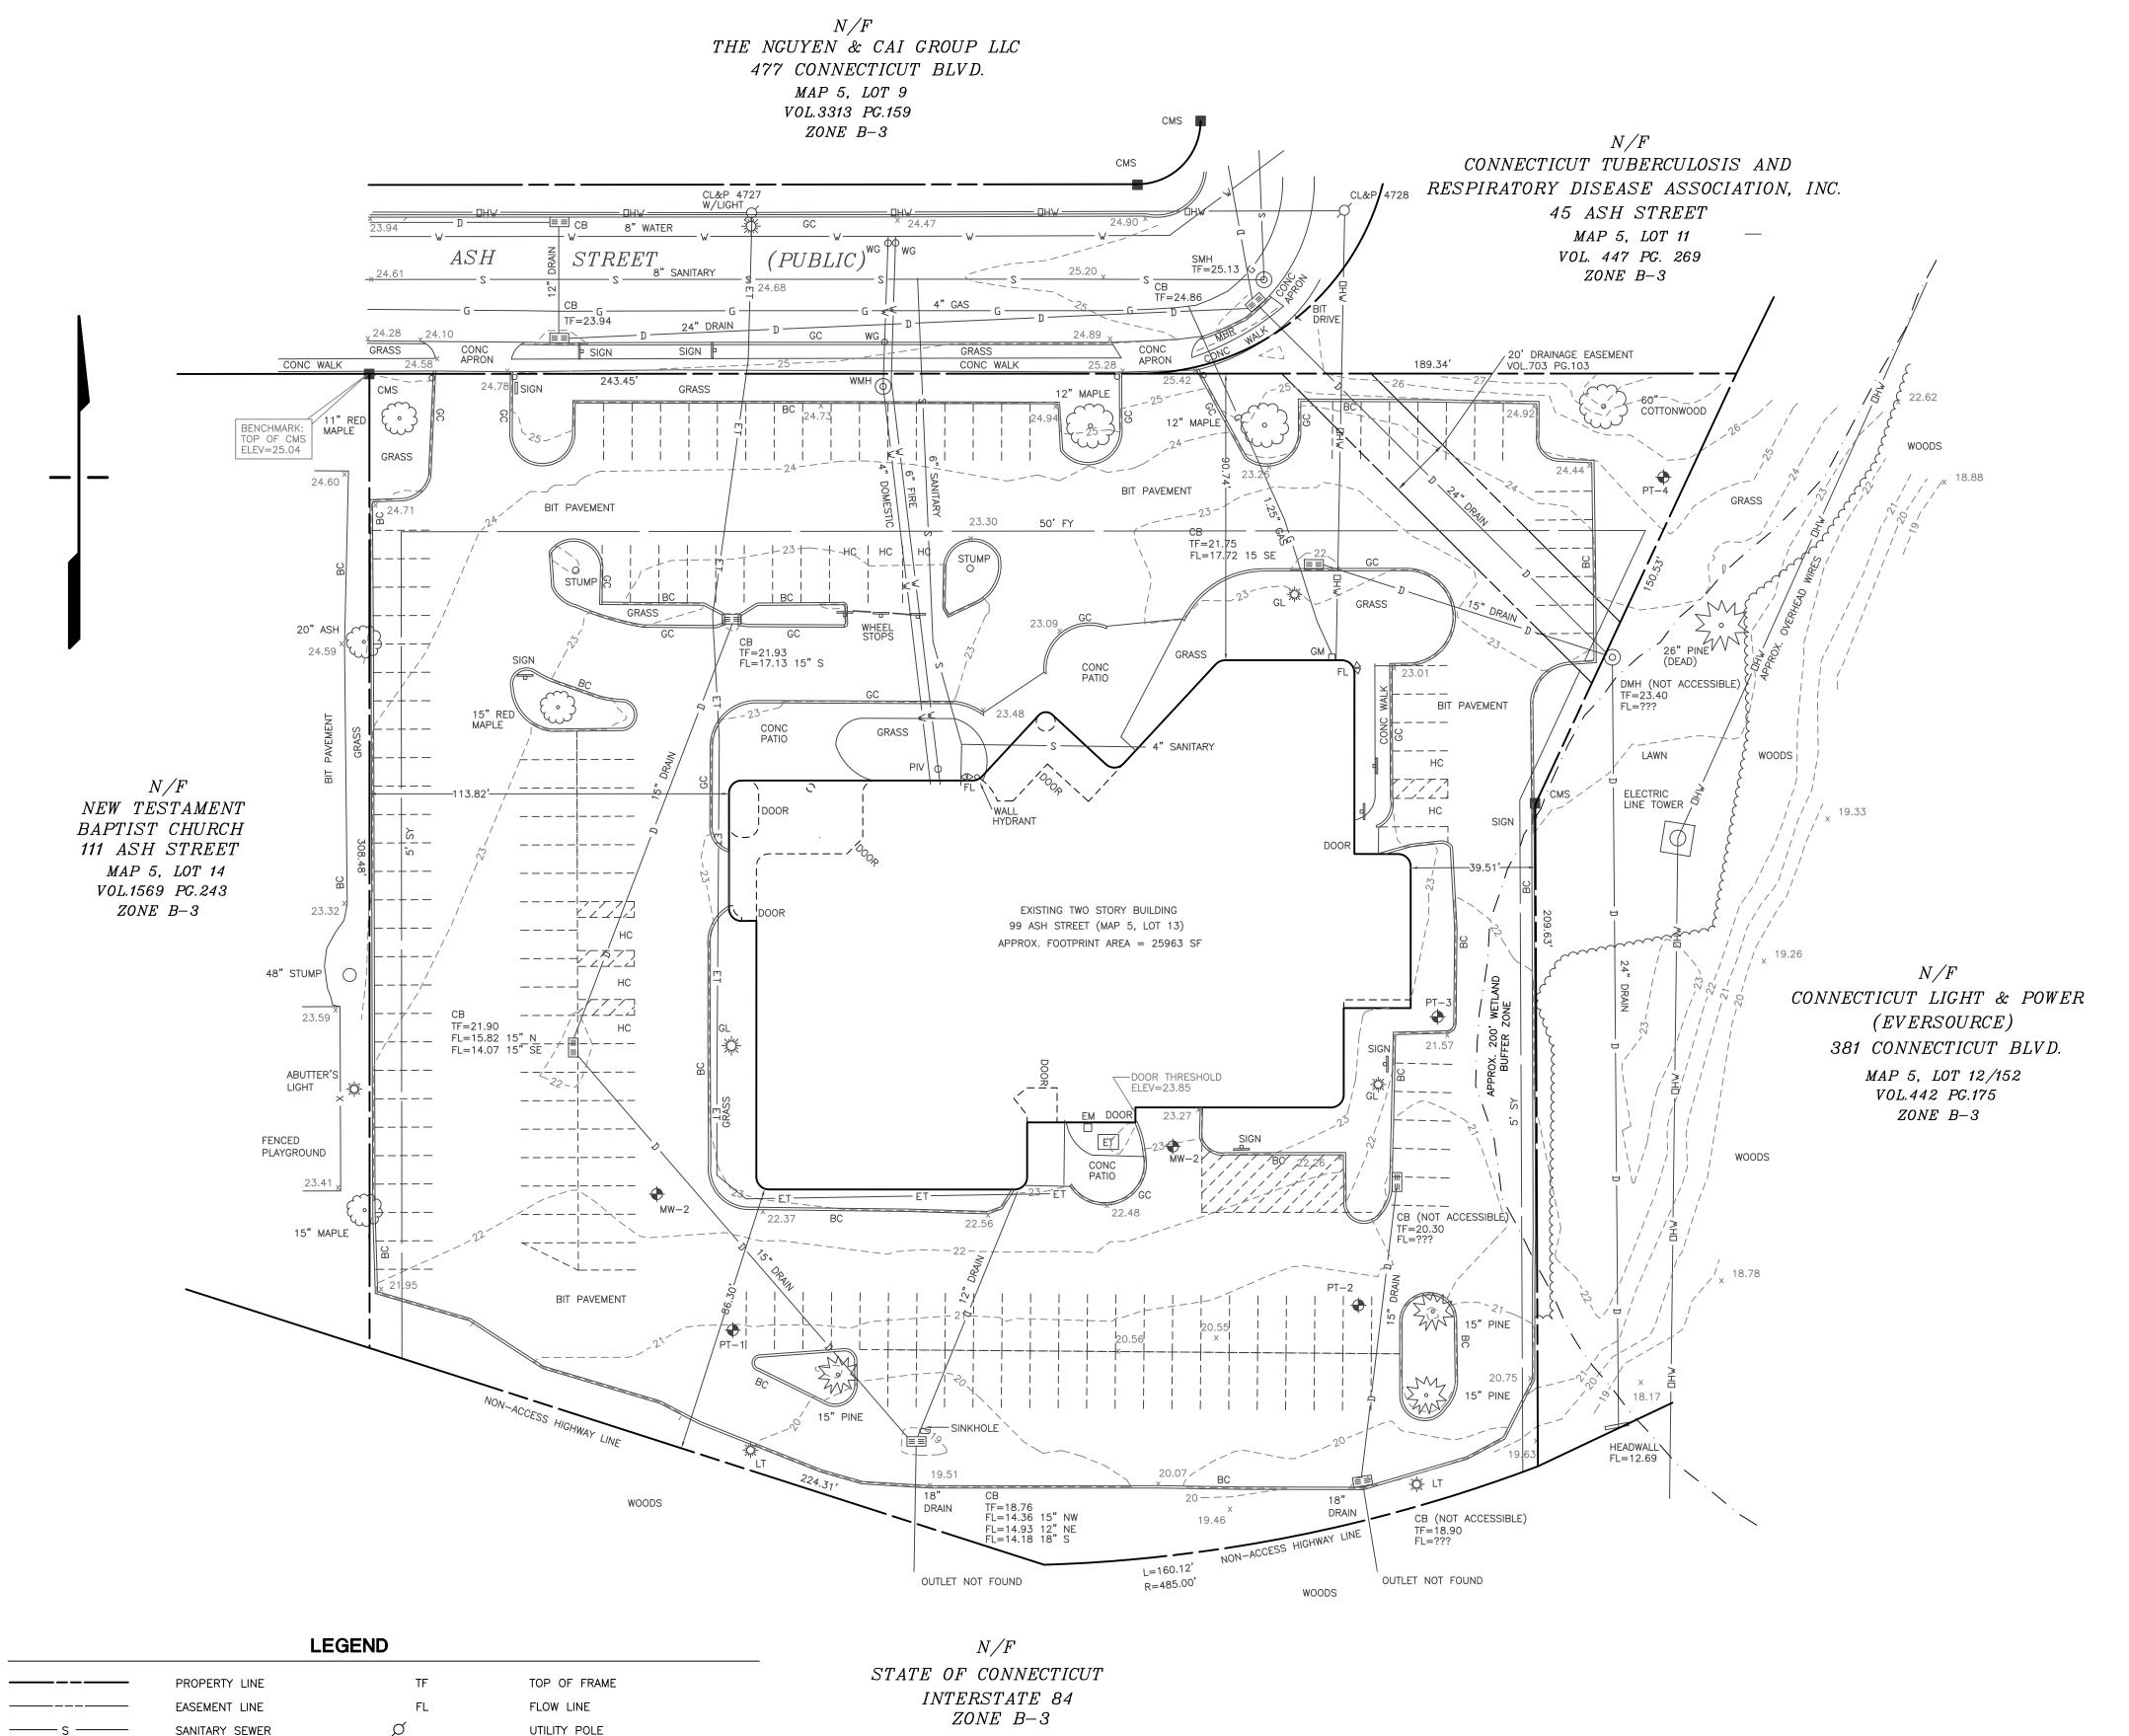

□ EM/GM

O WG

O PIV

ET

◆ PT−1

◆ MW−1

MBR

 $\sim\sim\sim\sim$

CMS

FY/SY/RY

ELECTRIC METER/GAS METER

POST INDICATOR VALVE

ELECTRIC TRANSFORMER

FRONT/SIDE/REAR YARDS

METAL BEAM GUIDERAIL

CONCRETE MERESTONE

HANDICAPPED PARKING SPACE

EDGE OF WOODS

IRON PIN

PERMEABILITY TEST LOCATION

TEMPORARY MONITORING WELL LOCATION

WATER GATE

OVERHEAD WIRES

STORM DRAINAGE

WATER SERVICE

ELECTRIC/TELEPHONE

EXISTING SPOT GRADE

DRAINAGE MANHOLE

SANITARY MANHOLE

WATER MANHOLE

GROUND LIGHT

FLOOD LIGHT

BIT CURB/GRANITE CURB

EXISTING CONTOUR

GAS SERVICE

CATCHBASIN

LIGHT POLE

——— OHW ———

---- 56----

x 56.25

BC/GC

≣≣ CB

O DMH

SMH

O WMH

∰ LT

-∰ GL

√ FL

ZONING TABLE


ZONE: B-3	REQUIRED	EXISTING
LOT AREA	40000 SF (1)	134590 SF
MIN. FRONTAGE	200 FT (1)	243.45 FT
MIN. FRONT YARD	50 FT (2)	90.74 FT
MIN. SIDE YARD	5 FT	39.51 FT
OTHER SIDE YARD	10 FT	113.82 FT
MIN. REAR YARD	N/A	86.30 FT
MAX. BLDG. HEIGHT	50 FT	27± FT
MAX. BLDG. COVERAGE	75%	19.3%
MAX. IMPV. COVERAGE	85%	82.0%
* DENOTES NON-CONFORM	MING TO CURRENT 2	ZONING REGULATIONS

- (1) NEW AUTOMOBILE SALES SECTION 403.1.13
- (2) FRONT YARD PER SECTION 212 (50 FT MAXIMUM)

PARKING TABLE

EXISTING PARKING

REGULAR SPACES	121	SPACES
HANDICAPPED SPACES	. 8	SPACES
TOTAL EXISTING PARKING	159	SPACES

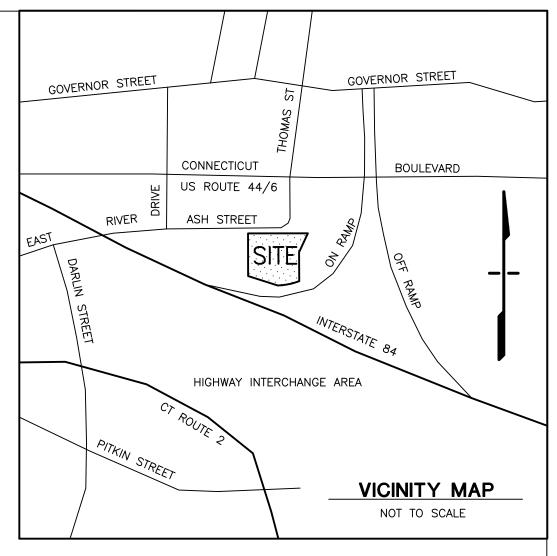

GENERAL NOTES

CALL BEFORE YOU DIG - DIAL 811 (1-800-922-4455): EXISTING UTILITIES HAVE BEEN PLOTTED FROM AVAILABLE SOURCES. THE LOCATIONS ARE ONLY APPROXIMATE AND THERE MAY BE ADDITIONAL UTILITIES WITHIN THE PROJECT AREA. THE CONTRACTOR SHALL VERIFY THE LOCATIONS OF ALL EXISTING UTILITIES WITHIN THE WORK AREA, NOTIFY EACH AFFECTED UTILITY COMPANY AND DIG TEST PITS AS REQUIRED PRIOR TO COMMENCING CONSTRUCTION. MEEHAN & GOODIN MAKES NO STATEMENT AS TO THE CONDITION OR SUITABILITY OF ANY UTILITIES FOR ANY INTENDED USE.

THIS PARCEL IS NOT WITHIN A NATURAL DIVERSITY DATA BASE AREA AS SHOWN ON THE DEEP NDDB MAP FOR EAST HARTFORD, CT, JUNE, 2017.

THERE ARE NO AQUIFER PROTECTION AREA ACCORDING TO THE INFORMATION ON THE DEEP AQUIFER PROTECTION AREAS MAP WEBSITE AS OF OCTOBER 2017.

THE ENTIRE PARCEL IS LISTED AS SOIL TYPE "307 URBAN LAND" ON THE NATIONAL COOPERATIVE SOIL SURVEY MAPPING FOR CONNECTICUT.

WETLAND BUFFER SHOWN BASED ON TOWN OF EAST HARTFORD INLAND WETLANDS AND WATERCOURSES MAP SHEET 15 OF 34, DATED 4-29-05.

GENERAL NOTES:

1. ALL MONUMENTATION DEPICTED HEREON WAS FOUND IN THE FIELD UNLESS OTHERWISE

- 2. BASIS OF BEARINGS: MAP REFERENCE NO.1.
- 3. VERTICAL INFORMATION BASED ON N.G.V.D.88 DATUM

MAP REFERENCES:

REFERENCE IS MADE TO THE FOLLOWING MAPS OR SURVEYS FROM WHICH DATA WAS USED IN THE PREPARATION OF THIS SURVEY AND MAP:

1. "SOUTH MEADOWS URBAN RENEWAL AREA TOWN OF EAST HARTFORD, CONNECTICUT SUBDIVISION PLAT SCALE: 1"=100' DATE: NOV.6, 1964 REVISED THRU 4-73 SHEET 1 OF 2" BY

2. "PROPERTY/ BOUNDARY SURVEY FOR ASH REALTY ASSOCIATES LLC PROPERTY KNOWN AS ASSESSOR'S LOT #13 SUBDIVISION TRACT #9B-1 & 9B-2 99 ASH STREET EAST HARTFORD, CONNECTICUT SCALE 1"=40' DATE FEBRUARY 15, 2008 REV. FEB.26, 2008 SHEET 1 OF 1" BY MBA ENGINEERING, INC.

3. "SITE PLAN NORTH CENTRAL CONN./H.M.O. SCALE: 1"=20' DATE: 3-31-79 PROJECT NO. 77-690 SHEET P-1" BY THE DEWOLFF PARTNERSHIP ARCHITECTS

NOTES AND DECLARATIONS:

THIS SURVEY AND MAP HAS BEEN PREPARED IN ACCORDANCE WITH THE REGULATIONS OF CONNECTICUT STATE AGENCIES, SECTIONS 20-300B-1 THRU 20-300B-20, THE MINIMUM STANDARDS FOR SURVEYS AND MAPS IN THE STATE OF CONNECTICUT ENDORSED BY THE CONNECTICUT ASSOCIATION OF LAND SURVEYORS, INC. THE TYPE OF SURVEY IS PROPERTY/BOUNDARY, THE BOUNDARY DETERMINATION CATEGORY IS RESURVEY, AND THE HORIZONTAL ACCURACY CONFORMS TO A-2, AND THE VERTICAL ACCURACY CONFORMS TO T-2.


NO DECLARATION IS EXPRESSED OR IMPLIED BY THIS MAP OR COPIES THEREOF UNLESS IT BEARS THE IMPRESSION TYPE SEAL AND ORIGINAL LIVE SIGNATURE OF THE SURVEYOR WHOSE NAME AND REGISTRATION NUMBER APPEAR BELOW. ANY CHANGES MADE TO THIS PLAN WITHOUT THE KNOWLEDGE OF THE SIGNERS INVALIDATES THESE DECLARATIONS.

I HEREBY DECLARE THAT TO THE BEST OF MY KNOWLEDGE, INFORMATION AND BELIEF:

> THE PREMISES DEPICTED HEREON IS LOCATED WITHIN "ZONE X" (AREAS PROTECTED BY LEVEES FROM 1% ANNUAL CHANCE FLOODPLAIN) AS SHOWN ON FEMA FLOOD INSURANCE RATE MAP NUMBER 09003C0369G, EFFECTIVE DATE SEPTEMBER 16, 2011:

> TO MY KNOWLEDGE AND BELIEF, THIS MAP IS SUBSTANTIALLY CORRECT AS NOTED HEREON.

RICHARD MEEHAN, L.L.S. 12330

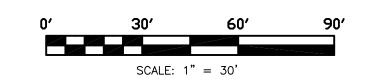

	F	REVISION		DATE	
L	SEAL & SIGNATURE:		NOTE:		
			SERVICE OF AN PROPERTY OF	IS AN INSTRUMENT OF ID REMAINS THE MEEHAN & GOODIN. IT	99 ASH STREET
			SPECIFIC PROJ MODIFIED WITH CONSENT OF M UNAUTHORIZED	O ONLY FOR THIS ECT AND SHALL NOT BE DUT THE WRITTEN MEEHAN & GOODIN. ANY MODIFICATIONS WILL	
			INVALIDATE ALL CERTIFICATIONS CONTAINED HEI	AND DECLARATIONS	SCALE: 1" = 30'
					DATE: 11-2-201

Meehan & Goodin Engineers - Surveyors, P.C.

387 North Main Street, Manchester, CT 06042 (860) 643-2520 FAX (860) 649-8806

PLAN PREPARED FOR

KIA OF EAST HARTFORD


EAST HARTFORD, CONN. **EXISTING CONDITIONS PLAN**

ACAD: 17113-ECP.DWG DESIGN: OT PROJECT: 17113 SHEET NO. 2 OF 10 DRAFT: ERJ Q://SC13/WORK

TOWN OF EAST HARTFORD PLANNING AND ZONING COMMISSION SITE PLAN CERTIFICATE OF APPROVAL

____ CHAIRMAN

APPROVAL DATE:_____ EXPIRATION DATE:_____

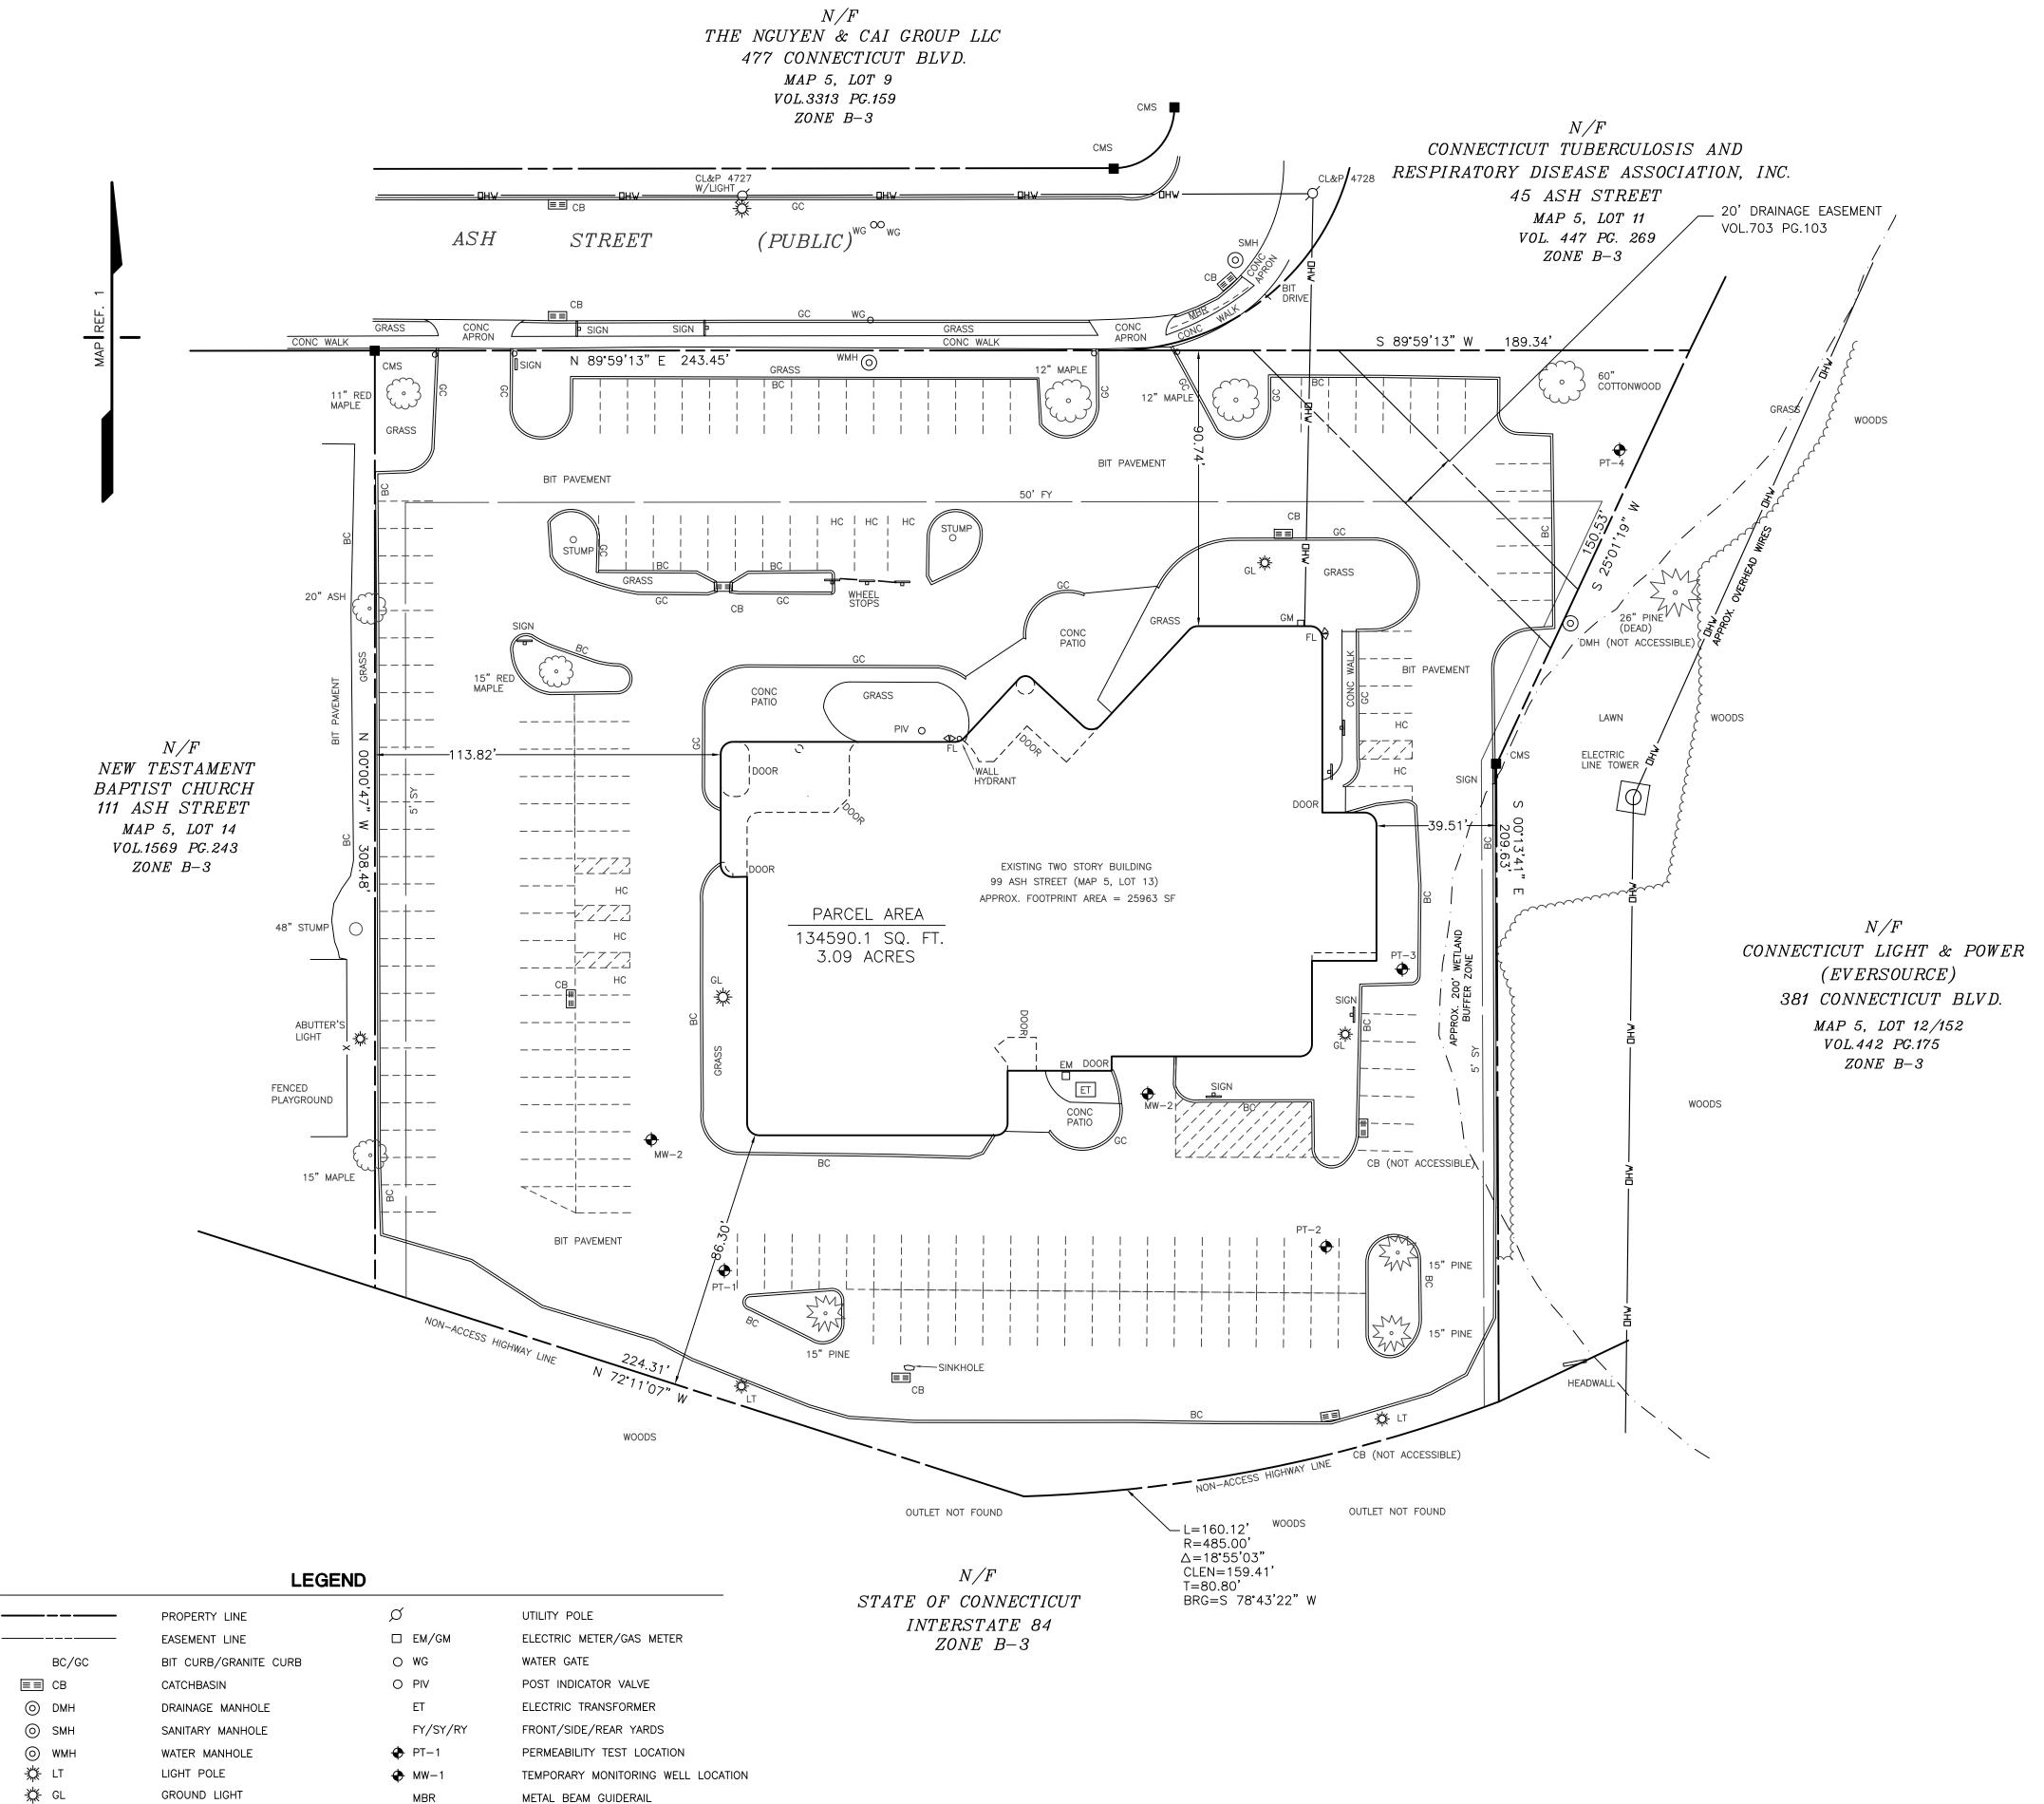

√ FL

FLOOD LIGHT

HANDICAPPED PARKING SPACE

 $\sim\sim\sim\sim$

CMS

EDGE OF WOODS

CONCRETE MERESTONE

IRON PIN

ZONING TABLE


ZONE: B-3	REQUIRED	EXISTING
LOT AREA	40000 SF (1)	134590 SF
MIN. FRONTAGE	200 FT (1)	243.45 FT
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* DENOTES NON-CONFORMING TO CURRENT ZONING REGULATIONS
(1) NEW AUTOMOBILE SALES - SECTION 403.1.13

(2) FRONT YARD PER SECTION 212 (50 FT MAXIMUM)

PARKING TABLE

EXISTING PARKING:		
REGULAR SPACES	151	SPACES
HANDICAPPED SPACES	. 8	SPACES
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GENERAL NOTES:

- 1. ALL MONUMENTATION DEPICTED HEREON WAS FOUND IN THE FIELD UNLESS OTHERWISE NOTED.
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- 3. VERTICAL INFORMATION BASED ON N.G.V.D.88 DATUM
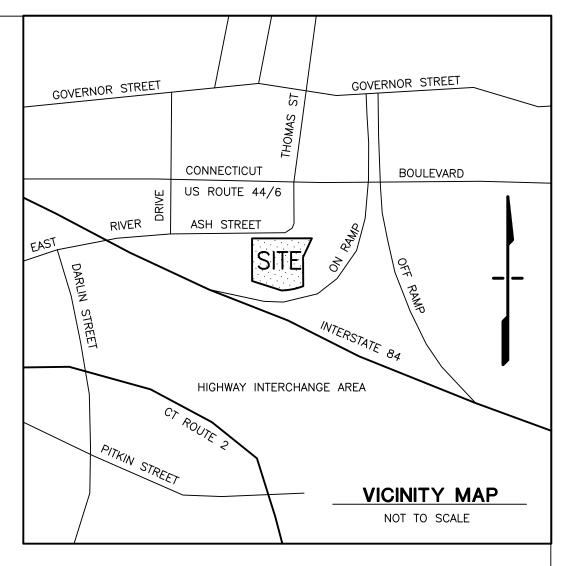
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5. WETLAND BUFFER SHOWN BASED ON TOWN OF EAST HARTFORD INLAND WETLANDS AND WATERCOURSES MAP SHEET 15 OF 34, DATED 4-29-05.

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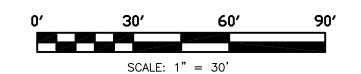
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RICHARD MEEHAN, L.L.S. 12330



REVISION

DATE

NOTE:

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PAGE 17 = 30'

TOWN OF EAST HARTFORD

PLANNING AND ZONING COMMISSION

SITE PLAN CERTIFICATE OF APPROVAL

APPROVAL DATE:_____

EXPIRATION DATE:_____

_____ CHAIRMAN

Meehan & Goodin Engineers - Surveyors, P.C.

387 North Main Street, Manchester, CT 06042 (860) 643-2520 FAX (860) 649-8806

PLAN PREPARED FOR

KIA OF EAST HARTFORD


EAST HARTFURD

EAST HARTFORD, CONN.

PROPERTY/BOUNDARY SURVEY

 SCALE: 1" = 30'
 DESIGN: RM
 PROJECT: 17113
 ACAD: 17113-PBS.DWG

 DATE: 11-2-2017
 DRAFT: SLH
 Q://SC13/WORK
 SHEET NO. 3 OF 10

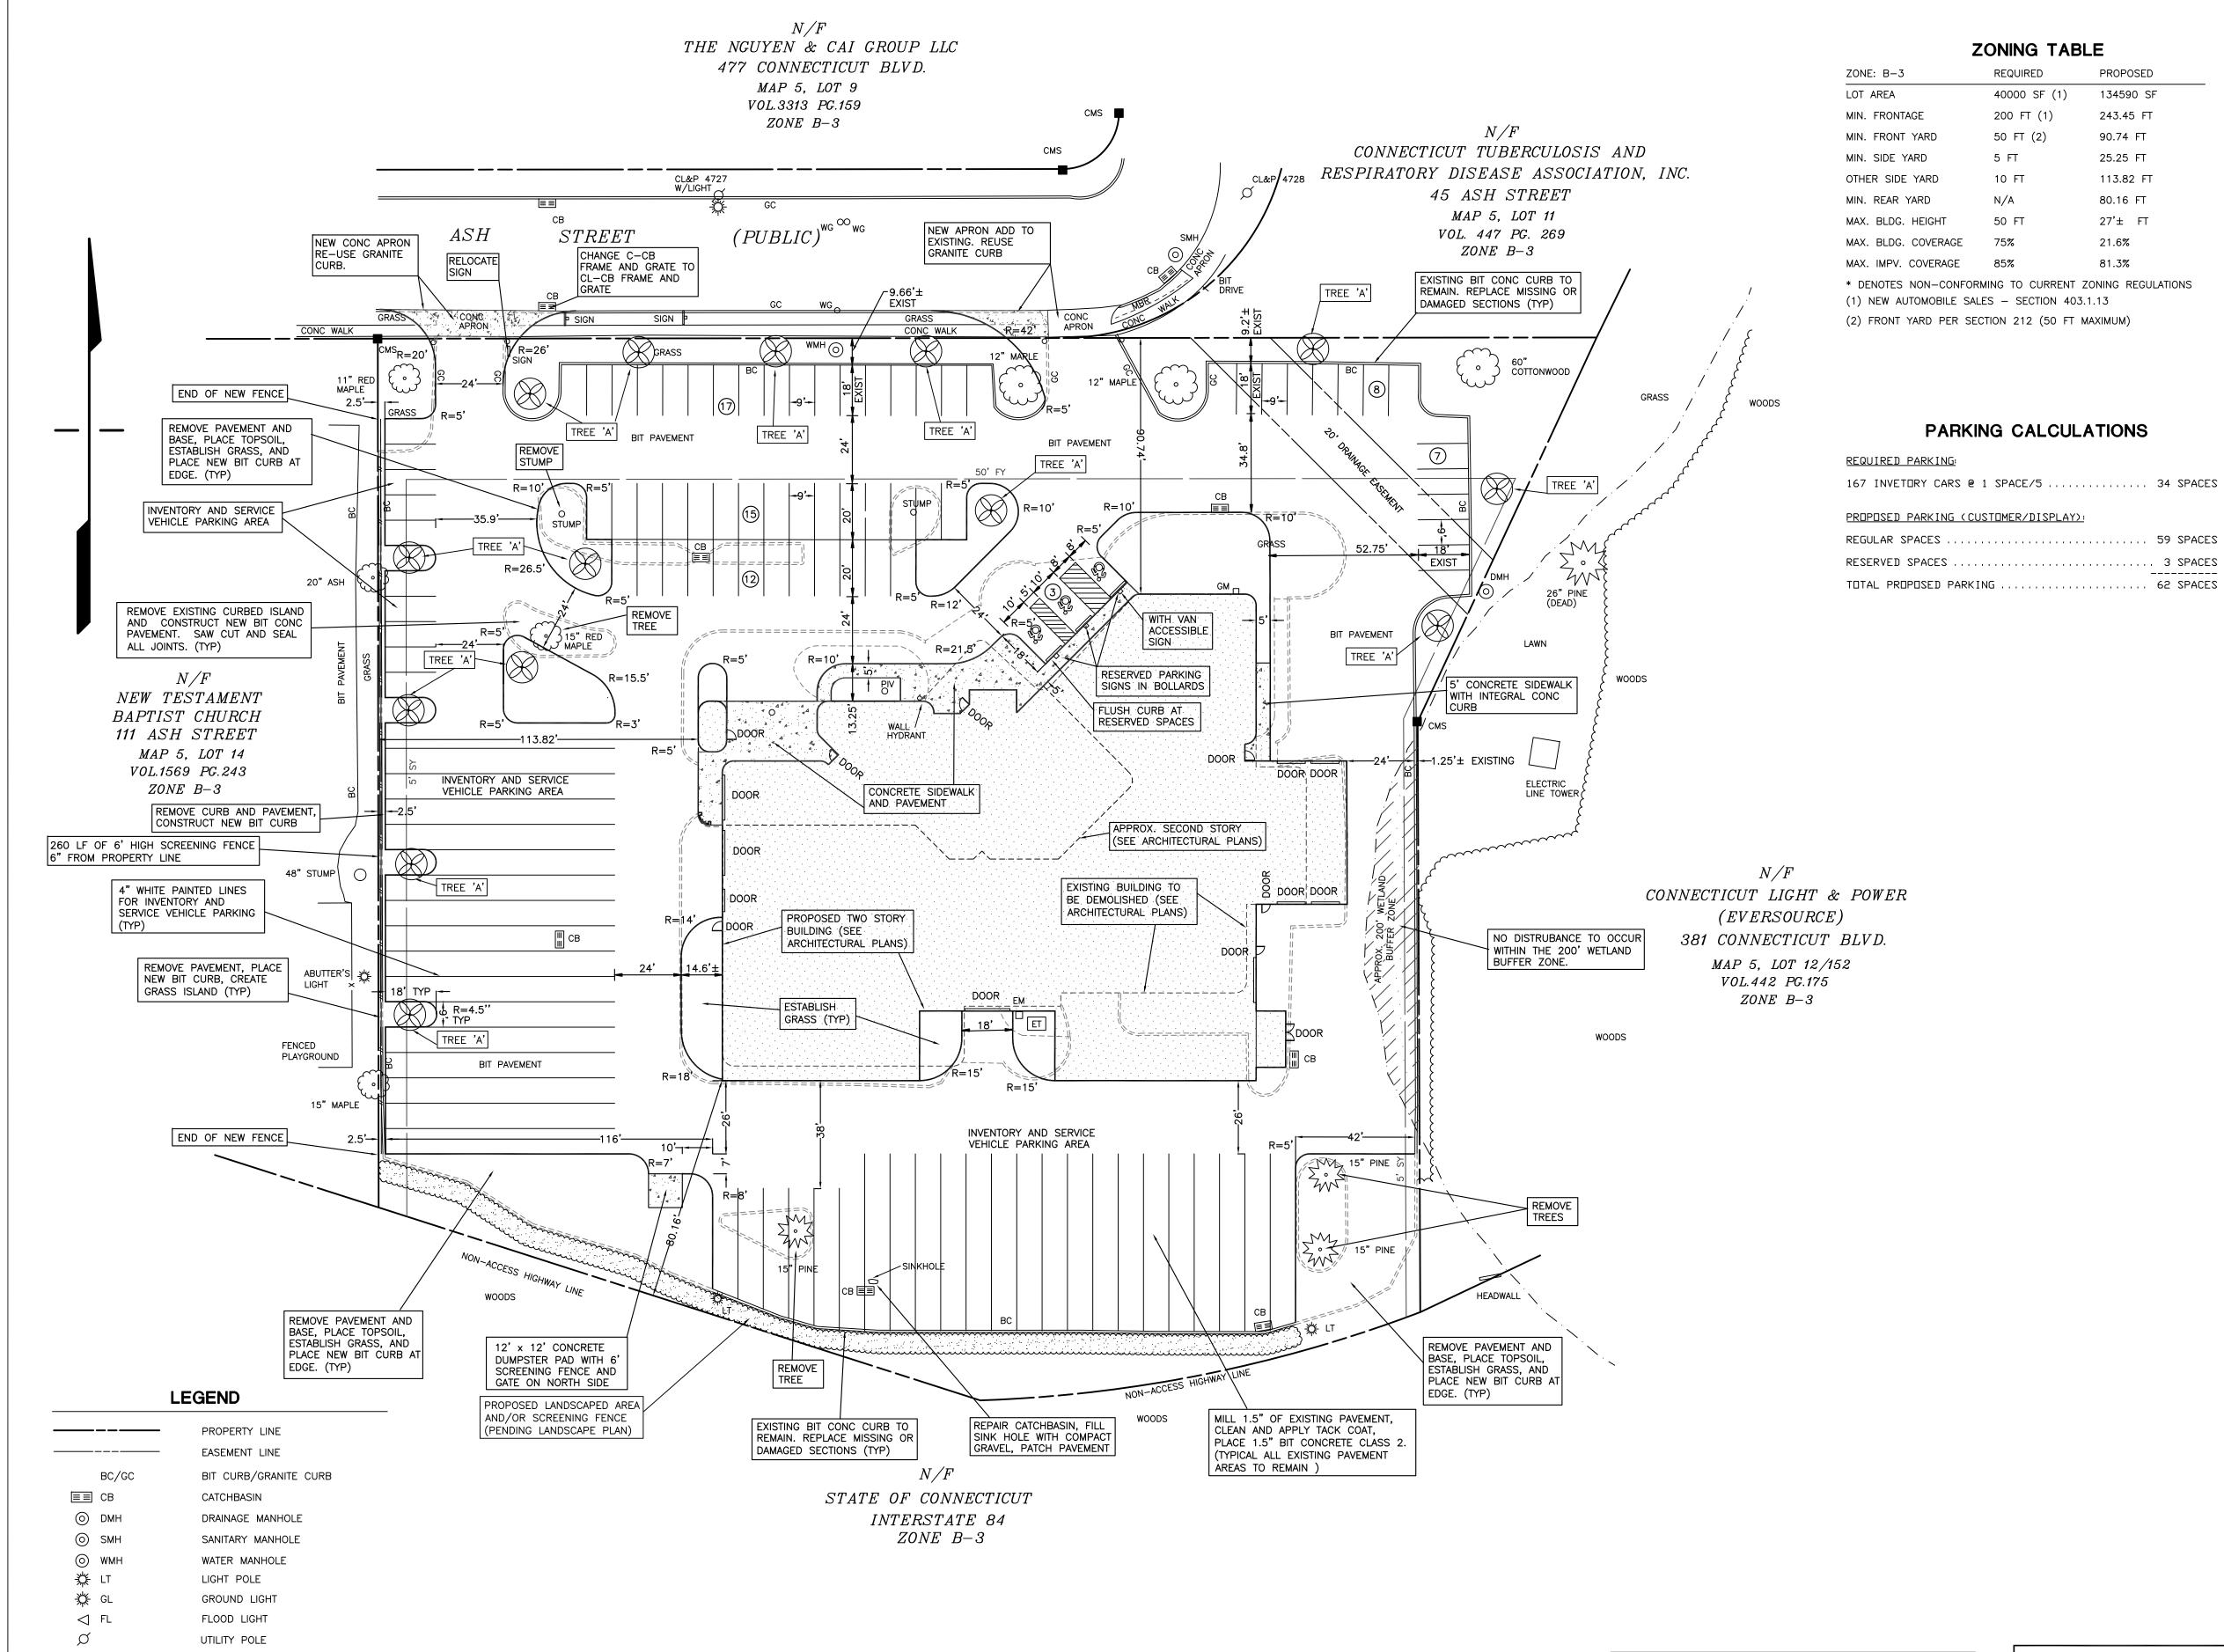

REQUIRED

200 FT (1)

50 FT (2)

5 FT

10 FT

50 FT

N/A

75%

40000 SF (1)

PROPOSED

134590 SF

243.45 FT

90.74 FT

25.25 FT

113.82 FT

80.16 FT

27**'**± FT

62 SPACES

21.6%

81.3%

PROFESSIONAL ENGINEER'S SEAL/SIGNATURE: ORIGINAL DOCUMENT CONTAINS THE LIVE SEAL AND LIVE SIGNATURE OF THE PROFESSIONAL ENGINEER. THIS DOCUMENT SHALL BE CONSIDERED UNSEALED AND UNSIGNED BY THE PROFESSIONAL ENGINEER IF SUCH SEAL AND SIGNATURE ARE MISSING OR IF IT CONTAINS A SEAL AND/OR SIGNATURE THAT ARE COPIES.

GENERAL NOTES

CALL BEFORE YOU DIG - DIAL 811 (1-800-922-4455): EXISTING UTILITIES HAVE BEEN PLOTTED FROM AVAILABLE SOURCES. THE LOCATIONS ARE ONLY APPROXIMATE AND THERE MAY BE ADDITIONAL UTILITIES WITHIN THE PROJECT AREA. THE CONTRACTOR SHALL VERIFY THE LOCATIONS OF ALL EXISTING UTILITIES WITHIN THE WORK AREA. NOTIFY EACH AFFECTED UTILITY COMPANY AND DIG TEST PITS AS REQUIRED PRIOR TO COMMENCING CONSTRUCTION. MEEHAN & GOODIN MAKES NO STATEMENT AS TO THE CONDITION OR SUITABILITY OF ANY UTILITIES FOR ANY INTENDED USE.

WETLAND BUFFER SHOWN BASED ON TOWN OF EAST HARTFORD INLAND WETLANDS AND WATERCOURSES MAP SHEET 15 OF 34, DATED 4-29-05.

ALL PROPRIETARY PRODUCTS AND MATERIALS SHALL BE INSTALLED AND MAINTAINED IN ACCORDANCE WITH THE MANUFACTURERS RECOMMENDATIONS.

ON ALL DISTURBED AREAS THAT WILL NOT BE COVERED BY BUILDING, PAVEMENT, OR OTHERWISE PERMANENTLY STABILIZED, PLACE TOPSOIL (6 INCH MINIMUM) AND ESTABLISH GRASS TURF UPON COMPLETION OF CONSTRUCTION.

THE CONTRACTOR SHALL ADJUST FINAL GRADES TO MEET FIELD CONDITIONS AND ALL AREAS SHALL BE GRADED TO DRAIN.

ANY IMPROVEMENTS SHOWN ON THIS PLAN OR REQUIRED RELATING TO PROPOSED WORK WITHIN THE TOWN OF EAST HARTFORD STREET LINES SHALL BE CARRIED OUT IN ACCORDANCE WITH THE STANDARDS AND REQUIREMENTS FOR WORK WITHIN THEIR STREET LINES.

ANY WORK WITHIN THE STATE OF CONNECTICUT PARCEL (INTERSTATE 84) RIGHT-OF-WAY) WILL REQUIRE REVIEW BY AND A PERMIT FROM THE CONNECTICUT DEPARTMENT OF TRANSPORTATION. THE CONTRACTOR SHALL BE RESPONSIBLE FOR APPLYING FOR THIS PERMIT PRIOR TO CONSTRUCTION. ALL WORK WITHIN THE STATE HIGHWAY LINES SHALL CONFORM TO THE STATE OF CONNECTICUT DEPARTMENT OF TRANSPORTATION "STANDARD SPECIFICATIONS FOR ROADS, BRIDGES AND INCIDENTAL CONSTRUCTION" FORM 816.

REFER TO THE ARCHITECTURAL DRAWINGS FOR ADDITIONAL INFORMATION, LAYOUT AND GRADES OF VARIOUS ITEMS.

ALL NEW TRANSITIONS FROM PAVEMENT AREAS TO FINISHED FLOORS WITHIN THE BUILDING SHALL BE FLUSH AT THE DOORS UNLESS SPECIFICALLY SHOWN OTHERWISE ON THE ARCHITECTURAL DRAWINGS.


THE DEVELOPER SHALL NOTIFY THE TOWN OF EAST HARTFORD ENGINEERING DIVISION 24 HOURS PRIOR TO BEGINNING ANY STORM DRAINAGE, ROADWAY PREPARATION, PAVING, SIDEWALK, CURBING. STREET LINE MONUMENTATION, PROPERTY CORNER PINS, ETC..., TO SCHEDULE INSPECTIONS. THE DIVISION CAN BE REACHED BETWEEN 8:30 AM - 4:30 PM AT 860-291-7380.

LANDSCAPING DATA

OWNER MAY SUBSTITUTE EQUIVALENT PLANTS (SIZE AND STYLE)

SYMBOL	LABEL	COMMON NAME	LATIN NAME	SIZE	QTY.
\otimes	Α	CLEVELAND SELECT PEAR	PYRUS CALLERYANA 'CLEVELAND SELECT'	3" CAL	15

TOWN OF EAST HARTFORD PLANNING AND ZONING COMMISSION SITE PLAN CERTIFICATE OF APPROVAL APPROVAL DATE:_____ EXPIRATION DATE:_____ SEAL & SIGNATURE: _____ CHAIRMAN

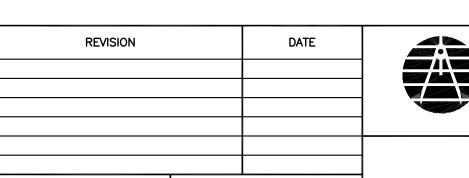

Meehan & Goodin

Engineers - Surveyors, P.C. 387 North Main Street, Manchester, CT 06042 (860) 643-2520 FAX (860) 649-8806

PLAN PREPARED FOR

SCALE: 1" = 30'

KIA OF EAST HARTFORD

EAST HARTFORD, CONN.

DESIGN: OT PROJECT: 17113 ACAD: 17113-SLP.DWG SHEET NO. 4 OF 10 DATE: 11-2-2017 DRAFT: ERJ Q://SC13/WORK

THIS DRAWING IS AN INSTRUMENT OF SERVICE OF AND REMAINS THE PROPERTY OF MEEHAN & GOODIN. IT IS TO BE USED ONLY FOR THIS SPECIFIC PROJECT AND SHALL NOT BE MODIFIED WITHOUT THE WRITTEN CONSENT OF MEEHAN & GOODIN. ANY UNAUTHORIZED MODIFICATIONS WILL INVALIDATE ALL SIGNATURES, CERTIFICATIONS AND DECLARATIONS CONTAINED HEREON. 99 ASH STREET SITE LAYOUT PLAN SCALE: 1" = 30'

IRON PIN CONCRETE MERESTONE CMS RESERVED PARKING SPACE HC (14) NUMBER OF SPACES IN THE ROW

WATER GATE

ELECTRIC METER/GAS METER

POST INDICATOR VALVE

ELECTRIC TRANSFORMER

FRONT/SIDE/REAR YARDS

METAL BEAM GUIDERAIL

EDGE OF WOODS

☐ EM/GM


FY/SY/RY

MBR

 $\sim\sim\sim\sim\sim$

O WG

O PIV

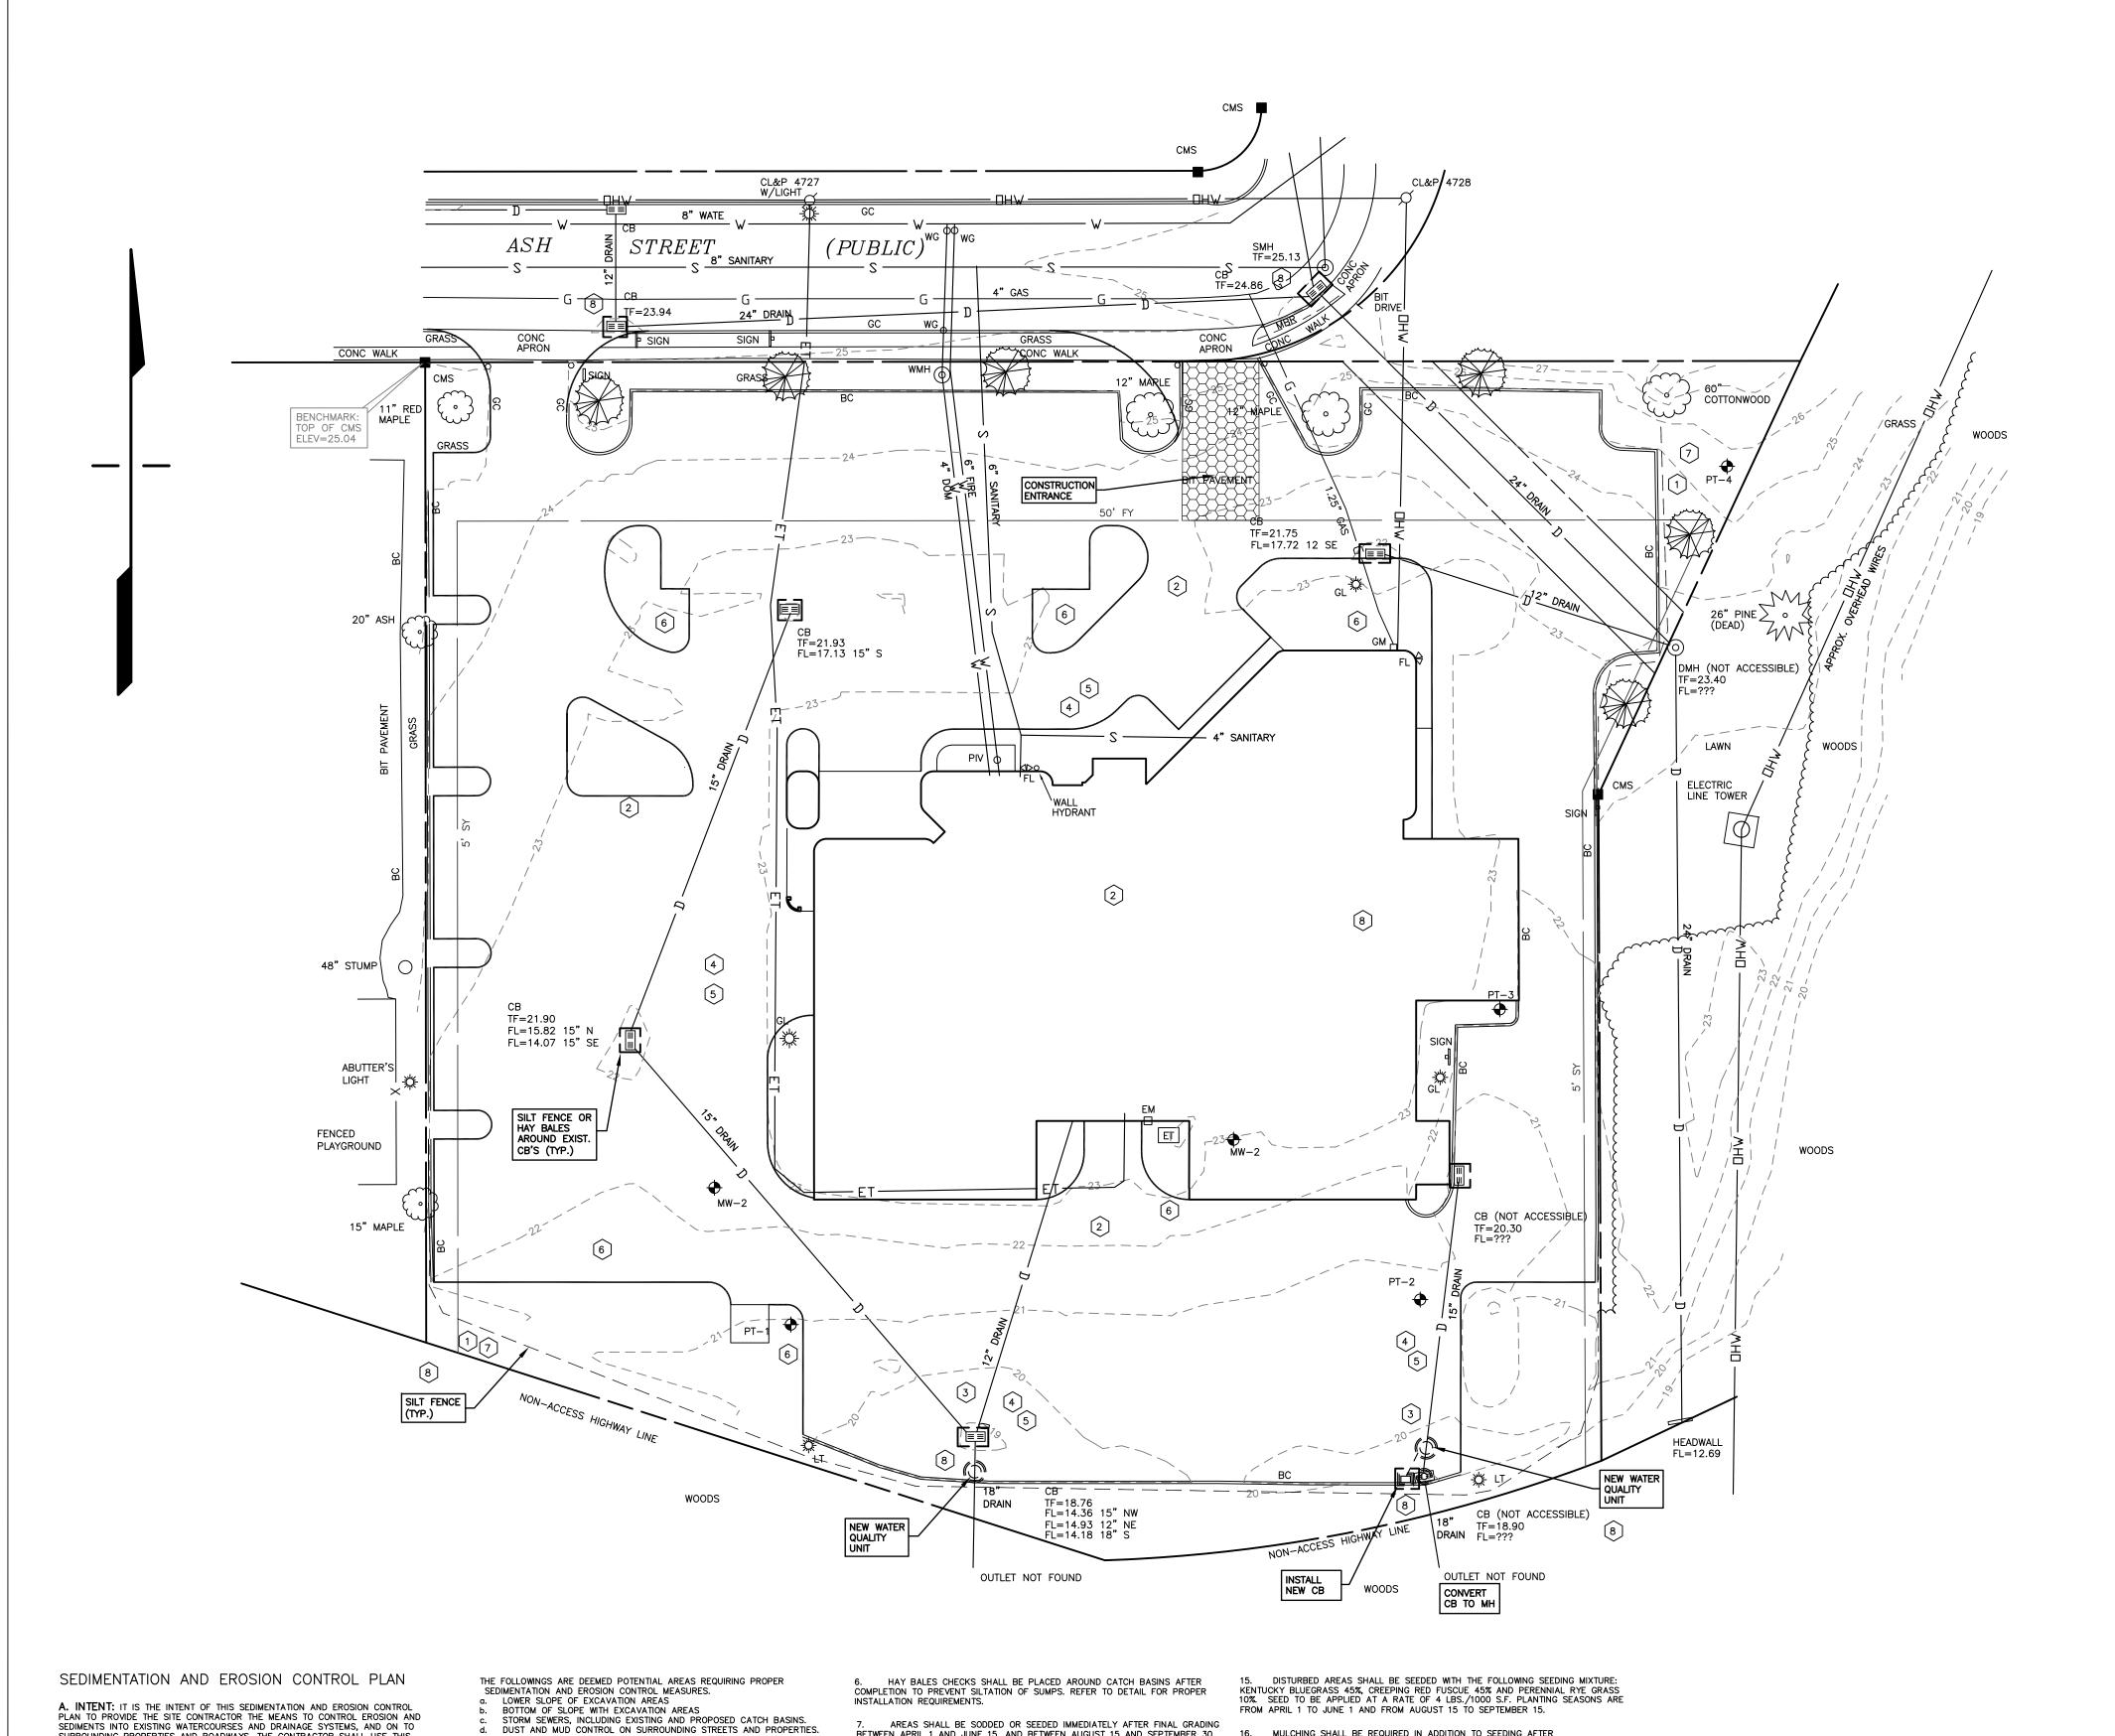

BETWEEN APRIL 1 AND JUNE 15, AND BETWEEN AUGUST 15 AND SEPTEMBER 30.

8. WHEN GRADING IS NOT COMPLETED BY SEPTEMBER 30, OR AREAS TO BE EXPOSED FOR EXTENDED PERIODS OF TIME, A TEMPORARY COVER OF ANNUAL RYE

GRASS SEEDED AT THE RATE OF 1.5 POUNDS PER 1000 SQUARE FEET SHALL BE

THE TOWN ENGINEER, OR HIS AGENT, SHALL BE NOTIFIED BEFORE

10. ALL CONTROL MEASURES SHALL BE INSPECTED WEEKLY FOR EXCESSIVE ACCUMULATIONS OF SILT. THESE INSPECTIONS SHALL BE INCREASED TO DAILY DURING PERIODS OF RAIN OR WHEN EXCESSIVE EROSION WITHIN A PARTICULAR

CONTROL MEASURES SHALL BE CLEANED OF SILT WHEN DEPTH

ALL CONTROL MEASURES ARE TO BE REMOVED FROM SITE IMMEDIATELY

AFTER WORK HAS BEEN COMPLETED AND GROUND COVER HAS BEEN ESTABLISHED.
PERIODIC REVIEW OF THE SITE MAY BE REQUIRED TO INSPECT THE SITE TO INSURE

THAT GRADED EMBANKMENTS MAINTAIN VEGETATION AS ESTABLISHED. IN THE EVENT THAT GROUND COVER HAS NOT BEEN FULLY ESTABLISHED IN A PARTICULAR

EXISTING STORM SEWERS, WATERCOURSES, AND CATCH BASINS SHALL BE

AREA, ADDITIONAL MEASURES MAY NEED TO BE TAKEN TO REESTABLISH THE

MUD OR SILT DURING CONSTRUCTION. MEASURES TO BE USED MAY INCLUDE

EITHER SWEEPING, APPLICATION OF WATER SPRAYS OR MULCHING TECHNIQUES.

CLEANED OF ANY ACCUMULATION OF SILT DUE TO CONSTRUCTION.

CONSTRUCTION BEGINS AND UPON COMPLETION.

PORTION OF SITE IS OCCURRING WITH REGULARITY.

ACCUMULATIONS REACH 1/2 THE OVERALL HEIGHT.

GROUND COVER.

SURROUNDING PROPERTIES AND ROADWAYS. THE CONTRACTOR SHALL USE THIS PLAN, ALONG WITH THE GUIDELINES PROVIDED, TO CONTAIN SEDIMENTS WITHIN

B. DESIGN CRITERIA: THE DESIGN CRITERIA USED TO PREPARE THIS PLAN WAS

BASED ON THE "2002 CONNECTICUT GUIDELINES FOR SOIL EROSION AND SEDIMENT CONTROL" AS AMENDED. WHILE TAKING INTO CONSIDERATION THE EXISTING NATURE AND TOPOGRAPHY OF THE SITE, AS WELL AS THE SPECIFICS OF THE PROPOSED PROJECT.

(PLEASE NOTE THE ABOVE NOTED DATES SHOULD BE ASSUMED AS TENTATIVE,

THE DEVELOPMENT, AS PROPOSED, INVOLVES THE CONSTRUCTION OF

THE PROPOSED DRAINAGE SYSTEM WILL INTO THE EXISTING DRAINAGE SYSTEM.

AND ARE SUBJECT TO CHANGE DUE TO CONDITIONS BEYOND THE CONTROL OF THE

SPECIFICALLY NOTED AREAS AS LISTED ON THIS PLAN.

C. STARTING DATE OF CONSTRUCTION: DEC., 2017

D. COMPLETION DATE OF CONSTRUCTION: MAR., 2018

E. AGENT RESPONSIBLE FOR IMPLEMENTATION OF PLAN:

F. DISCUSSION OF SITE AND DEVELOPMENT:
THE SITE IS LOCATED AT 99 ASH STREET IN THE TOWN OF EAST HARTFORD, CONNECTICUT.

THE SITE PRESENTLY DRAINS TO THE SOUTH.

THIS PLAN DEALS WITH THESE POTENTIAL SOURCES OF SEDIMENTS BY

1. ALL EMBANKMENT SLOPES, DISTURBED OR RE-GRADED DURING CONSTRUCTION SHALL BE SODDED OR SEEDED AND MULCHED (AS REQUIRED), AS SOON AS

2. SYNTHETIC FILTER FABRIC BARRIERS OR HAY BALES SHALL BE PLACED AS SHOWN ON THIS PLAN TO CONTROL SEDIMENTATION AND EROSION. REFER TO DETAIL FOR PROPER INSTALLATION REQUIREMENTS.

4. PRIOR TO CONSTRUCTION, ALL AREAS TO BE DISTURBED IN A PARTICULAR

THE PERIMETER OF THE PILE. TOPSOIL SHALL BE IMMEDIATELY SEEDED WITH A TEMPORARY COVER OF ANNUAL RYE GRASS.

LOCATION SHALL BE STRIPPED OF TOPSOIL AND STOCKPILED IN AN APPROPRIATE LOCATION. HAY BALES OR SYNTHETIC FILTER BARRIERS SHALL BE PLACED AROUND

HAY BALES OR SYNTHETIC FILTER BARRIERS SHALL BE PLACED AT ENDS OF ALL SWALES, EITHER PERMANENT OR TEMPORARY, IMMEDIATELY AFTER SWALE HAS

ALL PERIMETER SYNTHETIC FILTER CHECKS OR BARRIERS SHALL BE PLACED

PROPOSING SILTATION FENCES AND CHECKS, AND REQUIRING PROMPT STABILIZATION OF EXPOSED SLOPES.

WITH THE MANUFACTURER'S RECOMMENDATIONS AND THE STATE OF

G. SEDIMENTATION & EROSION CONTROL NOTES:

TRACKING

) LIQUID MULCH BINDERS

) MULCH NETTING

;) PEG AND TWINE

PRACTICAL AFTER COMPLETION OF SLOPES.

PRIOR TO STARTING OF ANY SITE CONSTRUCTION.

CHEMICAL MULCHES
MATS

ONNECTICUT SEDIMENTATION AND EROSION CONTROL GUIDELINES...

A) MULCH ANCHORING TOOL

20. ORGANIC MULCH ANCHORING WITH STRAW OR HAY MULCH MUST BE

ANCHORED IMMEDIATELY AFTER SPREADING TO PREVENT WIND BLOWING. THE FOLLOWING METHODS AND/OR PROCEDURES SHOULD BE USED IN ACCORDANCE

MULCHING SHALL BE REQUIRED IN ADDITION TO SEEDING AFTER

CONDITIONS, FOR SOIL CONDITIONS TEXTURES (CLAY, CLAY LOAM AND HIGH

20. ALL MULCHES MUST BE INSPECTED PERIODICALLY, IN PARTICULAR AFTER RAINSTORMS, TO CHECK FOR FILL EROSION. WHERE EROSION IS OBSERVED, ADDITIONAL MULCH SHOULD BE APPLIED. NET SHOULD BE INSPECTED AFTER

RAINSTORMS FOR DISLOCATION OR FAILURE. IF WASHOUTS OR BREAKAGE OCCURS, REINSTALL NET AS NECESSARY AFTER REPAIRING DAMAGE TO THE SLOPE(S).

WHERE SLOPES HAVE ERODED, AND SUBSEQUENT REPAIR MEASURES HAVE

INSPECTIONS SHOULD TAKE PLACE UNTIL GRASSED AREAS ARE FIRMLY ESTABLISHED TO CONTROL SOIL EROSION AND TO SURVIVE SEVERE WEATHER

DIVERSIONS AND OUTLET WATERWAY CHANNELS.

ACCORDANCE WITH MANUFACTURERS RECOMMENDATIONS.

CONTRACTOR TO KEEP ROADWAY FREE AND CLEAR OF ANY ACCUMULATED

OR SHIT DURING CONSTRUCTION AFFECTOR TO REPORT TO THE ACCUMULATED TO THE ACCUMULATED

A) APPLY FERTILIZER AT THE RATE OF 300 POUNDS PER ACRE OF

7.5 LBS/1000 S.F. OR 10-10-10 OR EQUIVALENT.

B) APPLY LIMESTONE (EQUIVALENT TO 50 PERCENT CALCIUM PLUS MAGNESIUM

OXIDE) AT A RATE OF 2 TONS/ACRE OR 135 LBS/1000 S.F. AS PER EXISTING SOIL

18. AREAS WHICH HAVE BEEN TEMPORARILY OR PERMANENTLY SEEDED SHALL BE MULCHED IMMEDIATELY FOLLOWING SEEDING. MULCH ANCHORING WILL BE USED ON SLOPES GREATER THAN 3 PERCENT AND CONCENTRATED FLOW AREAS SUCH AS

19. ORGANIC MULCH MAY BE USED IN ANY AREA WHERE MULCH IS REQUIRED. THE USE OF STRAW OR HAY AT THE RATE OF 1.5-2 TONS/ACRE OR 70-90 LBS/1000 S.F. AND BE FREE OF WEEDS AND COURSE MATTER, AND MUST BE ANCHORED AND SPREAD

22. INSTALLATION OF ALL CONTROL MEASURES TO BE DONE IN ACCORDANCE WITH THE "2002 CONNECTICUT GUIDELINES FOR SOIL EROSION AND SEDIMENT CONTROL", AS AMENDED, ADDITIONAL CONTROL MEASURES MAY HAVE TO BE ADDED TO THE SITE CONSTRUCTION AREAS WHERE SURFACE EROSION OR SEDIMENT CONTROL IS A PROBLEM. THE ABOVE REFERENCE MANUAL SHALL BE USED AS THE BASIS FOR THESE ADDITIONAL CONTROL MEASURES.

H. SEQUENCE OF SITE DEVELOPMENT AND INSTALLATION OF CONTROL MEASURES:

- $oxed{1}$ install silt fence and erosion protection around the limits of construction.
- 2 BUILDING AND PARKING CONSTRUCTION TO BEGIN.
- 3 INSTALL STORM SYSTEM AND OTHER UTILITIES. PROTECT INSTALLED CB WITH SILT FENCE AND HAY BALES.
- install final grading, curbing and pavement. Siltation checks to be reinstalled after pavement is installed.
- 5 FINAL GRADING OF SLOPES TO BE COMPLETED, INCLUDING PLACING AND FINAL GRADING OF TOPSOIL AND SEEDING.
- (6) INSTALL FINAL LANDSCAPING AND LAWN AREAS AS REQUIRED BY OWNER.
- SEDIMENTATION CONTROL MEASURES TO BE REMOVED AFTER VEGETATION IS FULLY ESTABLISHED ON SLOPES AND OTHER POTENTIAL AREAS OF EROSION HAVE BEEN CONTROLLED.
- ROADWAYS, SIDEWALKS AND ABUTTING ROADS TO BE CLEARED OF SILT AND DIRT AND DIRT DUE TO CONSTRUCTION. CATCH BASINS AND STORM DRAINS TO BE CLEANED OF ANY ACCUMULATED SILT. DOWNSTREAM CULVERTS AND/OR WATERCOURSES TO BE INSPECTED, AND CLEANED, OF ANY DEPOSITED SILT DUE TO CONSTRUCTION.

WATER POLLUTION CONTROL PLAN

A. SITE DESCRIPTION 1. NATURE OF THE CONSTRUCTION ACTIVITY

THE SITE IS BEING REDEVELOPED INTO A BUILDING AND PARKING. 2. SEQUENCE OF MAJOR SOIL DISTURBANCE ACTIVITIES ACTIVITY CONSTRUCTION SCHEDULE 2017-2018

ACTIVITY CONSTR	oc no	IN SUF	IEDUL	L 20	17-20	10
	DEC.	JAN.	FEB.	MAR.	APR.	MAY
INSTALL INITIAL EROSION CONTROL MEASURES	X	Х				
CLEARING AND GRUBBING	Ŷ	Ÿ				
CLEARING AND GRUBBING		\sim				
EXCAVATE AND INSTALL NEW BUILDING AND PARKING	Χ	Χ	Χ	Χ		
INSTALL STORM SYSTEM	Χ	Χ	Χ	Χ		
SITE GRADING		Χ	Χ	Χ		
SITE PAVING			Χ	Χ	Χ	
TOPSOIL AND FINAL GRADING			Χ	Χ	Χ	
STABILIZE EMBANKMENTS			Χ	Χ	Χ	
LANDSCAPING				Χ	Χ	Χ
CLEAN UP				Χ	Χ	Χ

SITE AREA

- THE AREA OF THE CONSTRUCTION IS APPROXIMATELY 2.75 ACRES. THE SITE WILL BE DISTURBED AS THE PARKING IS DEVELOPED.
- 4. RUNOFF COEFFICIENT THE AVERAGE RUNOFF COEFFICIENT OF THE SITE AFTER CONSTRUCTION IS APPROX. 0.60.
- 5. SITE MAP THE SITE PLAN INCLUDED HEREIN PROVIDES ALL INFORMATION ON SLOPES AND GRADING REQUIRED.
- 6. RECEIVING WATERS
- THE RUNOFF FROM THE SITE WILL BE DISCHARGED TO THE EXISTING STORM

B. CONTROLS

- 1. EROSION AND SEDIMENT CONTROLS ARE SHOWN ON THIS PLAN. 2. STRUCTURAL PRACTICES
- THE PROPOSED STORM SYSTEM IS DESIGNED AS A MAIN SYSTEM OF MANHOLE TO MANHOLE WITH THE CATCH BASINS GOING TO MANHOLES ONLY. THE CATCH BASINS ARE EQUIPPED WITH TRAPS TO ALLOW THE HEAVY SOILS AND SILT TO FALL OUT, FLOATABLES TO BE TRAPPED AND OILS TO REMAIN IN THE CATCH BASINS.
- 3. MAINTENANCE PROGRAM DURING CONSTRUCTION ALL CATCH BASINS SHALL BE CLEANED AND CLEARED OF DEBRIS, SAND OR SILT ON A BIWEEKLY BASIS. DEBRIS SHALL BE REMOVED FROM THE SITE ALONG WITH OTHER CONSTRUCTION DEBRIS SILT AND SAND MAY BE SPREAD IN FLAT OR LEVEL AREAS ATED TO BE TOD SOILED OF CRADED SILT FENCE OR HAY BALE PROTECTION SHALL BE REPAIRED AS NEEDED AND NOTED ABOVE. ACCUMULATED SILT SHALL BE REMOVED OR SPREAD PER THE EROSION

4. DEWATERING WASTE WATERS

ANY DEWATERING ON SITE SHALL BE TO A CONTROLLED FLAT AREA OR AN EXCAVATED SUMP AREA ENCIRCLED WITH HAY BALES OR SILTFENCE. NO WATER SHALL BE ALLOWED TO ENTER THE STORM SYSTEM WITHOUT BEING DETAINED TO

5. POST CONSTRUCTION STORM WATER MANAGEMENT

CONTROL PLAN ELSEWHERE ON THIS SHEET.

A. CATCH BASIN SUMPS WILL BE CLEANED ON A SIX MONTH BASIS. REMOVED MATERIAL WILL BE TAKEN OFF SITE. OILS WILL BE SKIMMED OFF THE WATER SURFACE ON A SIX MONTH BASIS OR AS A PROBLEM MAY DICTATE. PROPER REMOVAL OF OILS WILL BE CONDUCTED AS REQUIRED.

- 6. OTHER CONTROLS
- ALL CONSTRUCTION DEBRIS WILL BE REMOVED FROM THE SITE AS SOON AS POSSIBLE. NO DEBRIS WILL BE ALLOWED TO ENTER THE STORM SYSTEM. THE CONTRACTORS WILL REMOVE ANY DEBRIS ACCIDENTALLY OR OTHERWISE DEPOSITED IN THE STORM
- WATER POLLUTION PREVENTION AND EROSION CONTROL MEASURES SHALL BE CHECKED FOR DAMAGE DISREPAIR OR REPLACEMENT BY AN INSPECTOR AT A MINIMUM INTERVAL OF ONCE A WEEK UNTIL THE SITE IS STABILIZED. AFTER THE SITE IS STABILIZED,

INSPECTIONS SHALL BE CONDUCTED ONCE A MONTH FOR THREE MONTHS.

OF THE STORMWATER POLLUTION CONTROL PLAN PREPARED FOR THIS SITE."

- C. CONTRACTORS
- ALL CONTRACTORS AND SUBCONTRACTORS WORKING ON THIS PROJECT WHICH MAY REASONABLY BE EXPECTED TO CAUSE OR HAVE THE POTENTIAL TO CAUSE POLLUTION OF THE WATERS OF THE STATE, SHALL SIGN THE FOLLOWING CERTIFICATION: "I CERTIFY UNDER PENALTY OF THE LAW THAT I HAVE READ AND UNDERSTAND THE TERMS AND CONDITIONS OF THE GENERAL PERMIT FOR THE DISCHARGE OF STORMWATER ASSOCIATED WITH CONSTRUCTION ACTIVITY. I UNDERSTAND THAT AS A CONTRACTOR OR SUBCONTRACTOR AT THE SITE, I AM COVERED BY THIS GENERAL PERMIT, AND MUST COMPLY WITH THE GENERAL CONDITIONS OF THIS PERMIT, INCLUDING BUT NOT LIMITED TO THE REQUIREMENTS

GENERAL UTILITY NOTES

1. ALL SITE DEMOLITION/CONSTRUCTION SHALL BE IN ACCORDANCE WITH THE TOWN OF EAST HARTFORD, PUBLIC WORKS DEPARTMENT, ENGINEERING DEPARTMENT AND THE PUBLIC IMPROVEMENT STANDARDS.

2. THE UNDERGROUND UTILITIES SHOWN ON THIS PLAN HAVE BEEN OBTAINED FROM AVAILABLE RECORDS AND HAVE BEEN LOCATED IN THE FIELD WHERE POSSIBLE. THE ACTUAL LOCATION OF THESE UTILITIES SHOULD BE VERIFIED BY THE CONTRACTOR. THE CONTRACTOR MUST CONTACT "CALL BEFORE YOU DIG"

UTILITIES PRIOR TO ANY EXCAVATION. 3. SANITARY AND STORM SERVICE SHALL MEET THE REQUIREMENTS

1-800-922-4455 FOR LOCATION AND MARKING OF ALL EXISTING

OF THE TOWN OF EAST HARTFORD. 4. ELECTRICAL, TELEPHONE, CABLE, AND COMMUNICATIONS SERVICE

SHALL MEET THE REQUIREMENTS OF THE INDIVIDUAL UTILITY

5. ALL DAMAGE TO PUBLIC FACILITIES WITHIN THE STREET RIGHT OF WAY DURING SITE CONSTRUCTION SHALL BE REPAIRED BY THE APPLICANT.

6. ACCESS TO THE SITE SHALL DURING CONSTRUCTION SHALL BE THROUGH THE CONSTRUCTION ENTRANCES AS SHOWN ON THE PLAN AND NO OTHER ACCESS SHALL BE ALLOWED.

7. PIPE LENGTHS SHOWN ARE FROM CENTER TO CENTER OF STRUCTURES. CONTRACTOR IS TO CUT PIPES FLUSH WITH STRUCTURE WALLS.

NOTE:

CONTRACTOR IS RESPONSIBLE FOR REMOVING SEDIMENT THAT ACCUMULATES IN THE DOWNSTREAM OFF-SITE DRAINAGE SYSTEMS AS A RESULT OF THE PROJECT. SEE SEDIMENT AND EROSION CONTROL PLAN NOTES SECTION H, SEQUENCE #8.



TOWN OF EAST HARTFORD PLANNING AND ZONING COMMISSION SITE PLAN CERTIFICATE OF APPROVAL APPROVAL DATE:_____ EXPIRATION DATE:_____ CHAIRMAN

SEAL & SIGNATURE: NOTE: THIS DRAWING IS AN INSTRUMENT OF SERVICE OF AND REMAINS THE PROPERTY OF MEEHAN & GOODIN. IT IS TO BE USED ONLY FOR THIS SPECIFIC PROJECT AND SHALL NOT BE MODIFIED WITHOUT THE WRITTEN CONSENT OF MEEHAN & GOODIN. ANY UNAUTHORIZED MODIFICATIONS WILL INVALIDATE ALL SIGNATURES, CERTIFICATIONS AND DECLARATIONS CONTAINED HEREON.

REVISION

99 ASH STREET

Meehan & Goodin Engineers – Surveyors, P.C. 387 North Main Street, Manchester, CT 06042


> (860) 643-2520 FAX (860) 649-8806 PLAN PREPARED FOR

KIA OF EAST HARTFORD

EAST HARTFORD, CONN.

GRADING AND UTILITIES WITH EROSION CONTROL PLAN DESIGN: OT PROJECT: 17113 ACAD: 17113.DWG

SCALE: 1" = 30'DATE: 11-2-2017 DRAFT: DT Q://SC13/WORK SHEET NO. <u>5</u> OF <u>10</u>

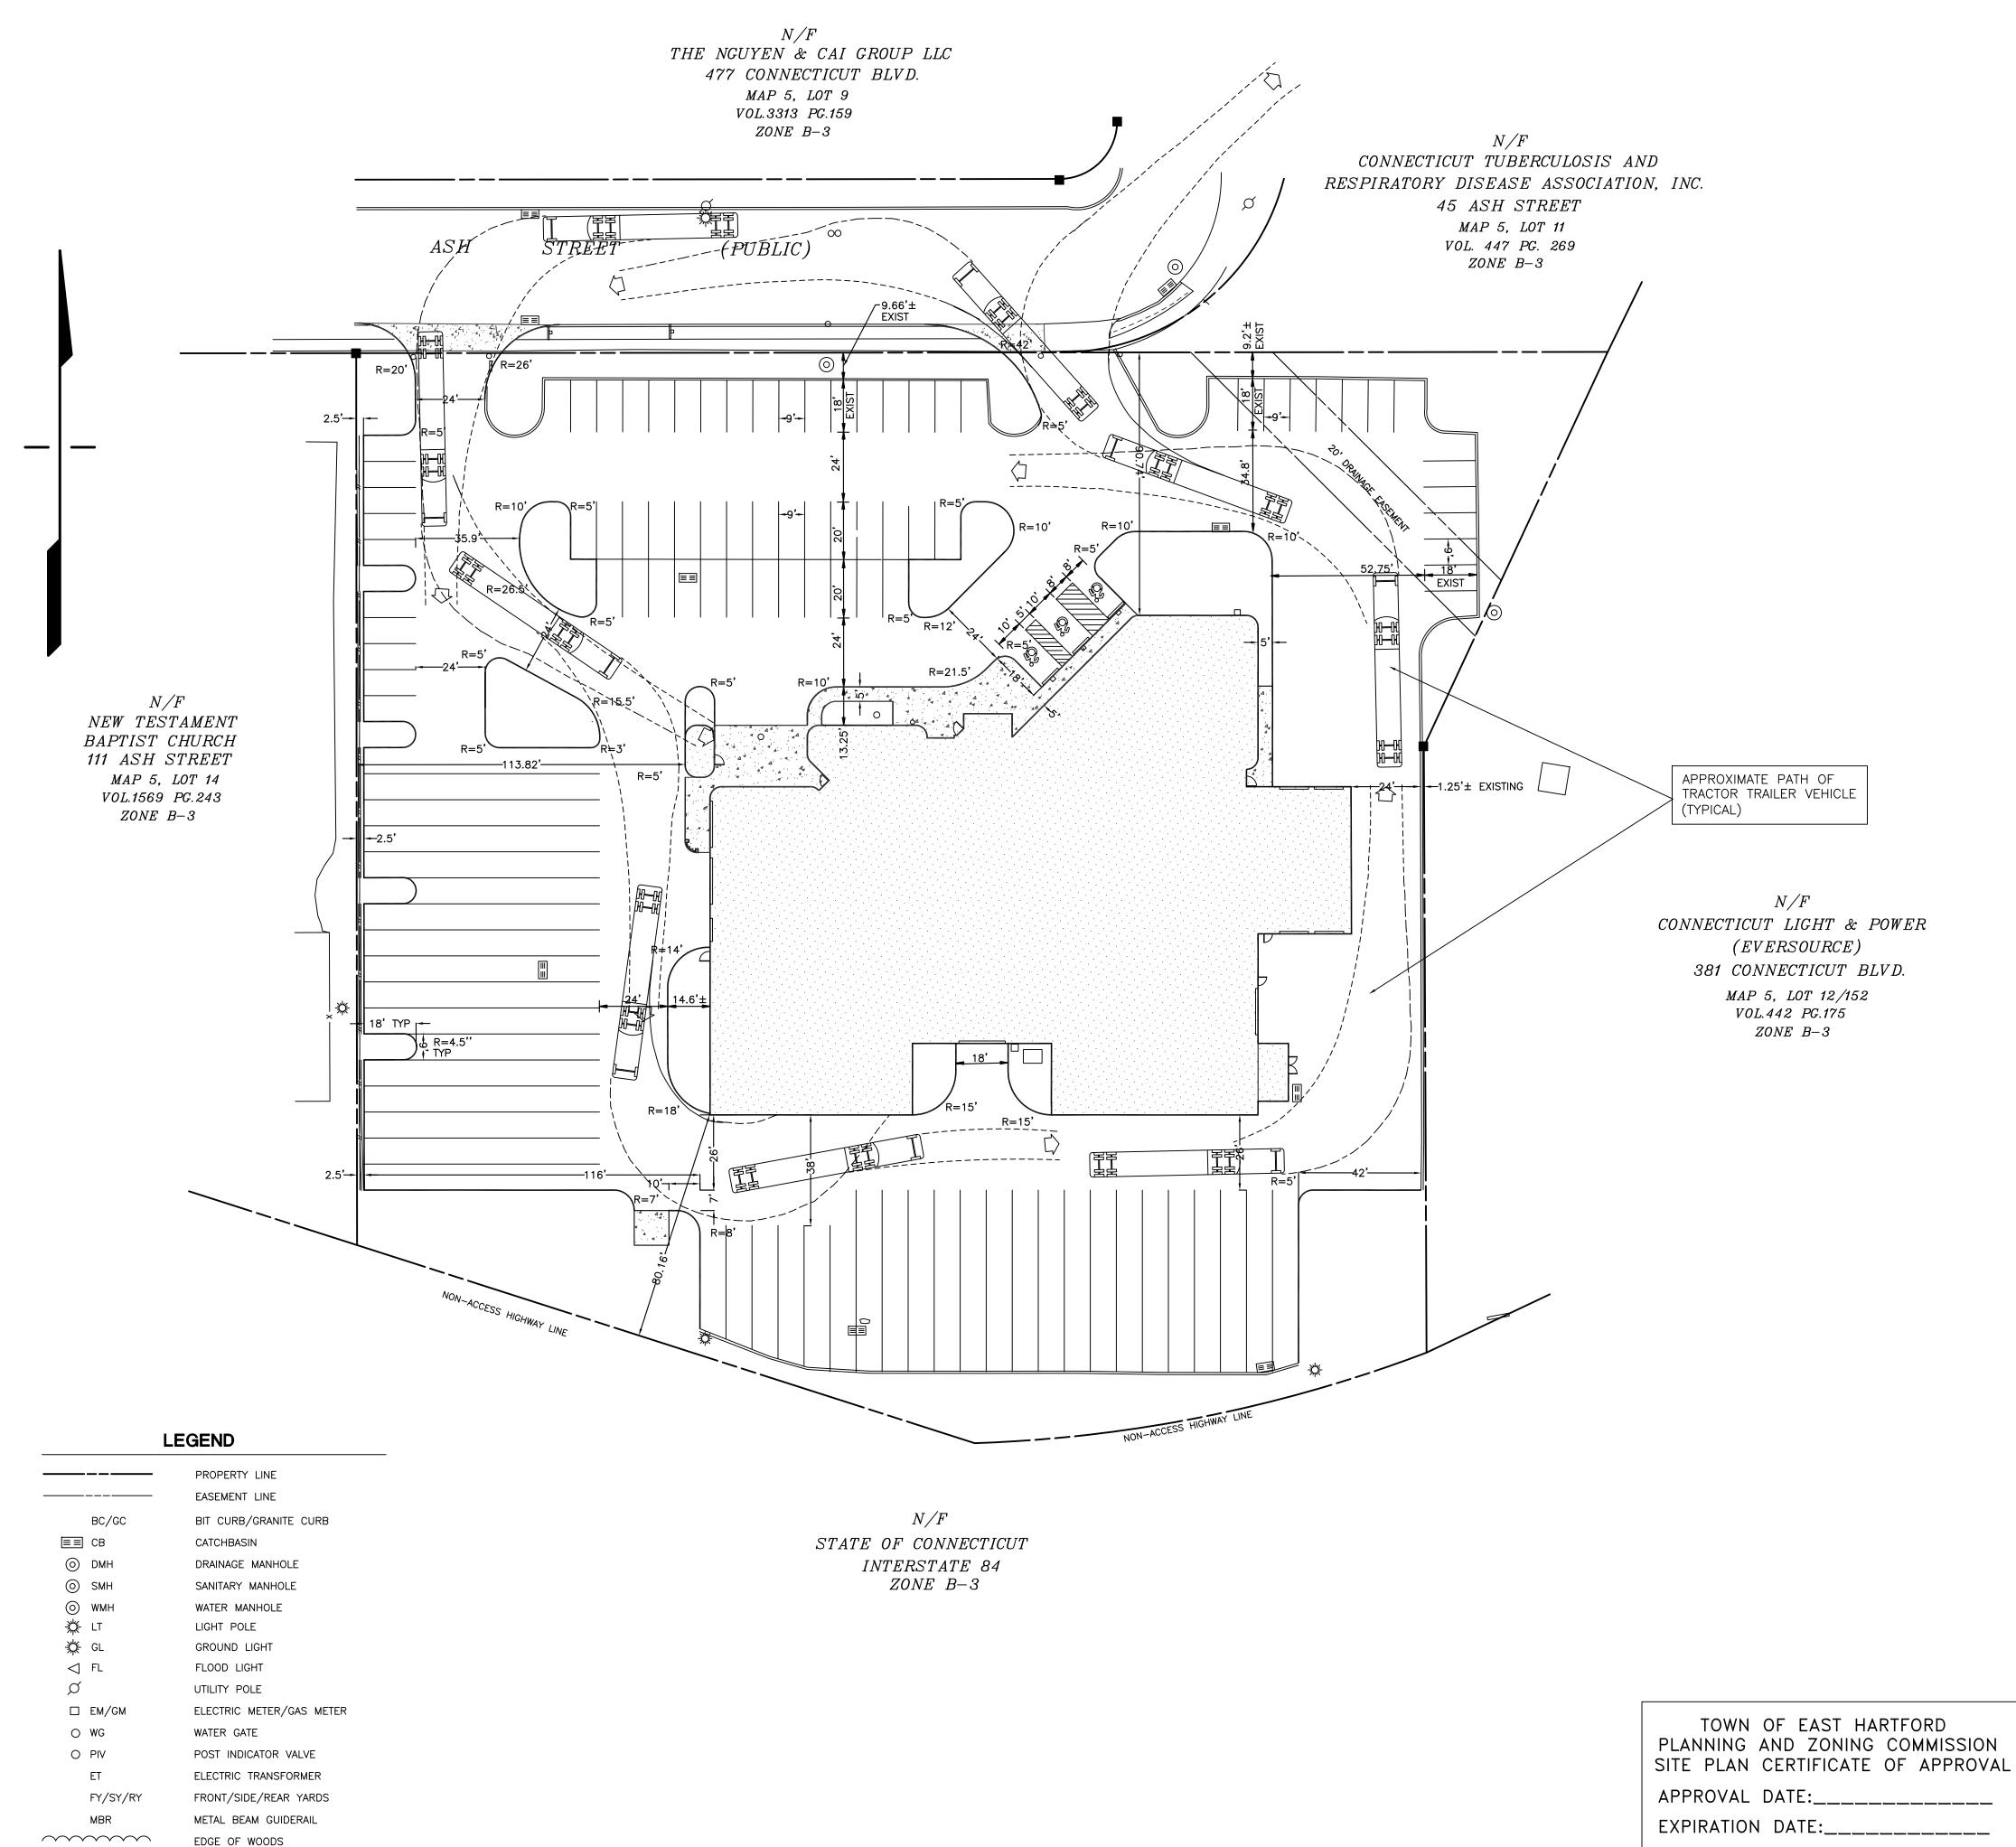

IRON PIN

CMS

HC

14)

CONCRETE MERESTONE

RESERVED PARKING SPACE


NUMBER OF SPACES IN THE ROW

GENERAL NOTES

PROFESSIONAL ENGINEER'S SEAL/SIGNATURE: ORIGINAL DOCUMENT CONTAINS THE LIVE SEAL AND LIVE SIGNATURE OF THE PROFESSIONAL ENGINEER. THIS DOCUMENT SHALL BE CONSIDERED UNSEALED AND UNSIGNED BY THE PROFESSIONAL ENGINEER IF SUCH SEAL AND SIGNATURE ARE MISSING OR IF IT CONTAINS A SEAL AND/OR SIGNATURE THAT ARE COPIES.

CALL BEFORE YOU DIG - DIAL 811 (1-800-922-4455): EXISTING UTILITIES HAVE BEEN PLOTTED FROM AVAILABLE SOURCES. THE LOCATIONS ARE ONLY APPROXIMATE AND THERE MAY BE ADDITIONAL UTILITIES WITHIN THE PROJECT AREA. THE CONTRACTOR SHALL VERIFY THE LOCATIONS OF ALL EXISTING UTILITIES WITHIN THE WORK AREA, NOTIFY EACH AFFECTED UTILITY COMPANY AND DIG TEST PITS AS REQUIRED PRIOR TO COMMENCING CONSTRUCTION. MEEHAN & GOODIN MAKES NO STATEMENT AS TO THE CONDITION OR SUITABILITY OF ANY UTILITIES FOR ANY INTENDED USE.

THIS DRAWING IS INTENDED TO PRESENT THE VEHICLE TURNING DIAGRAMS AND IS NOT TO BE USED FOR CONSTRUCTION. REFER TO THE OTHER SITE PLANS FOR CONSTRUCTION.

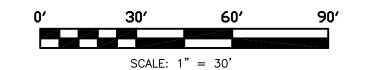

SEAL & SIGNATURE: THIS DRAWING IS AN INSTRUMENT OF SERVICE OF AND REMAINS THE PROPERTY OF MEEHAN & GOODIN. IT IS TO BE USED ONLY FOR THIS SPECIFIC PROJECT AND SHALL NOT BE MODIFIED WITHOUT THE WRITTEN CONSENT OF MEEHAN & GOODIN. ANY UNAUTHORIZED MODIFICATIONS WILL INVALIDATE ALL SIGNATURES, CERTIFICATIONS AND DECLARATIONS CONTAINED HEREON. _____ CHAIRMAN

DATE	REVISION

99 ASH STREET

Meehan & Goodin

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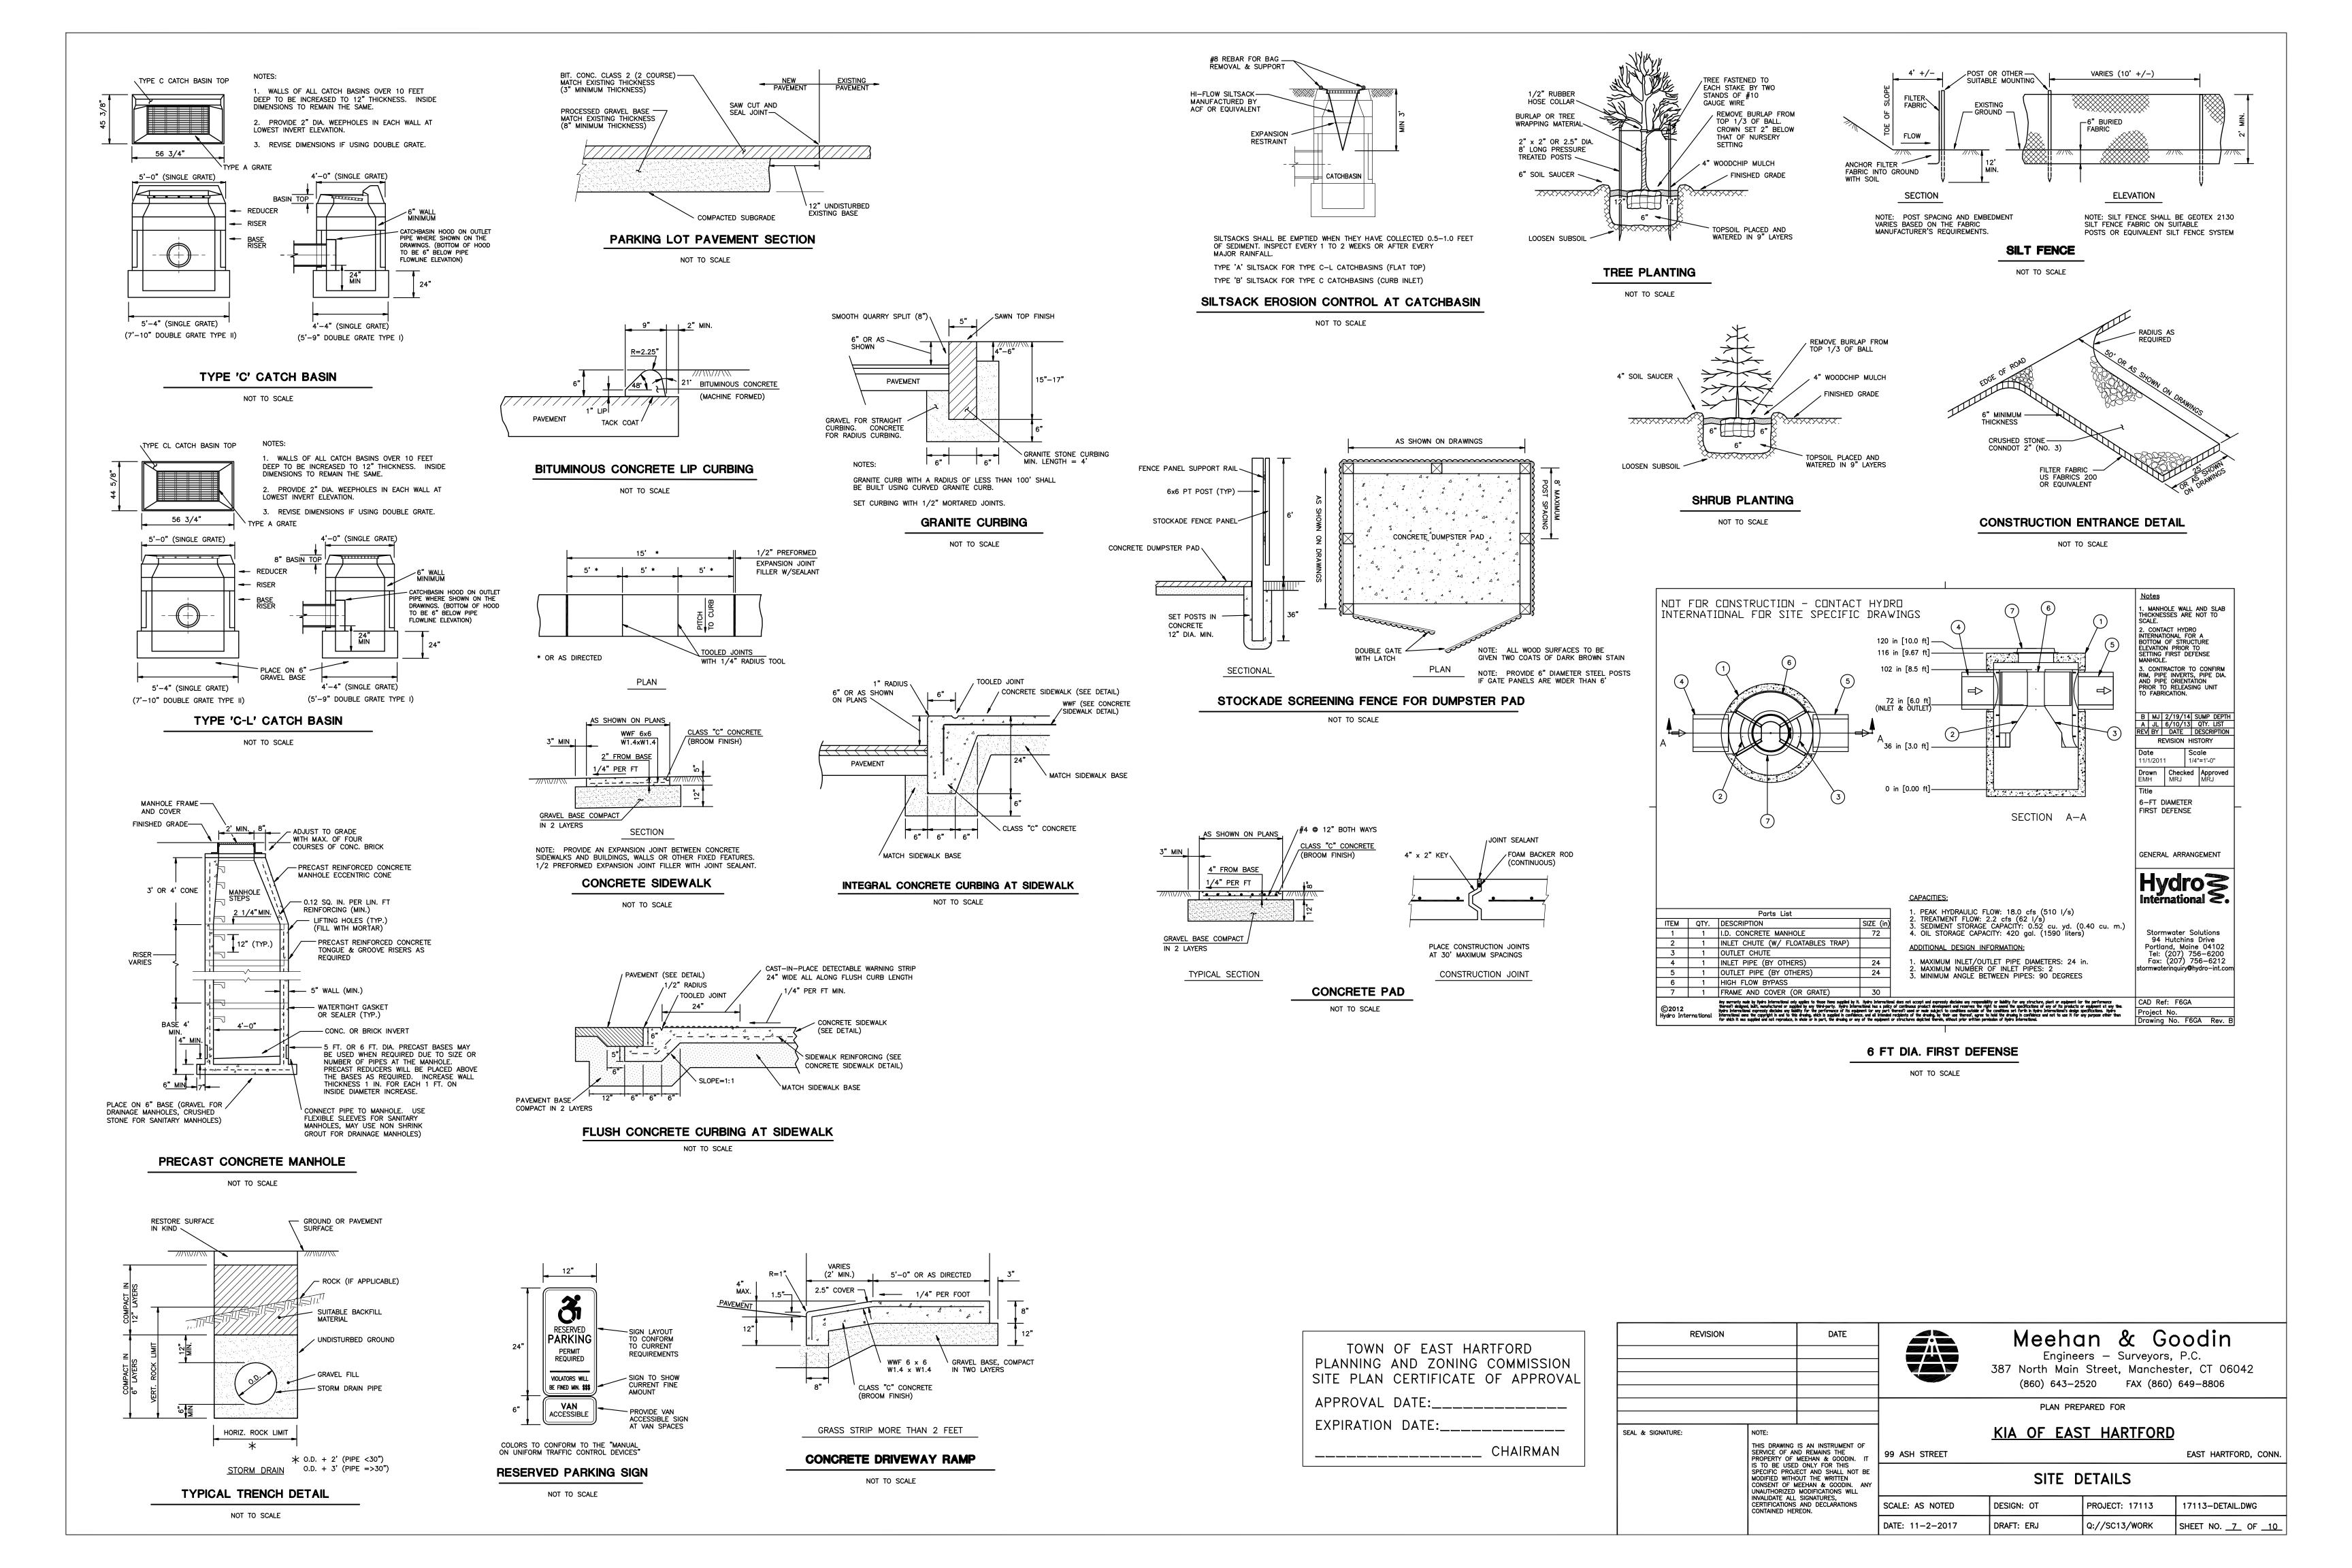
PLAN PREPARED FOR


KIA OF EAST HARTFORD

EAST HARTFORD, CONN.

VEHICLE TURNING DIAGRAMS


SCALE: 1" = 30' DESIGN: OT PROJECT: 17113 ACAD: 17113-SLP.DWG DATE: 11-2-2017 DRAFT: ERJ Q://SC13/WORK SHEET NO. <u>6</u> OF <u>10</u>



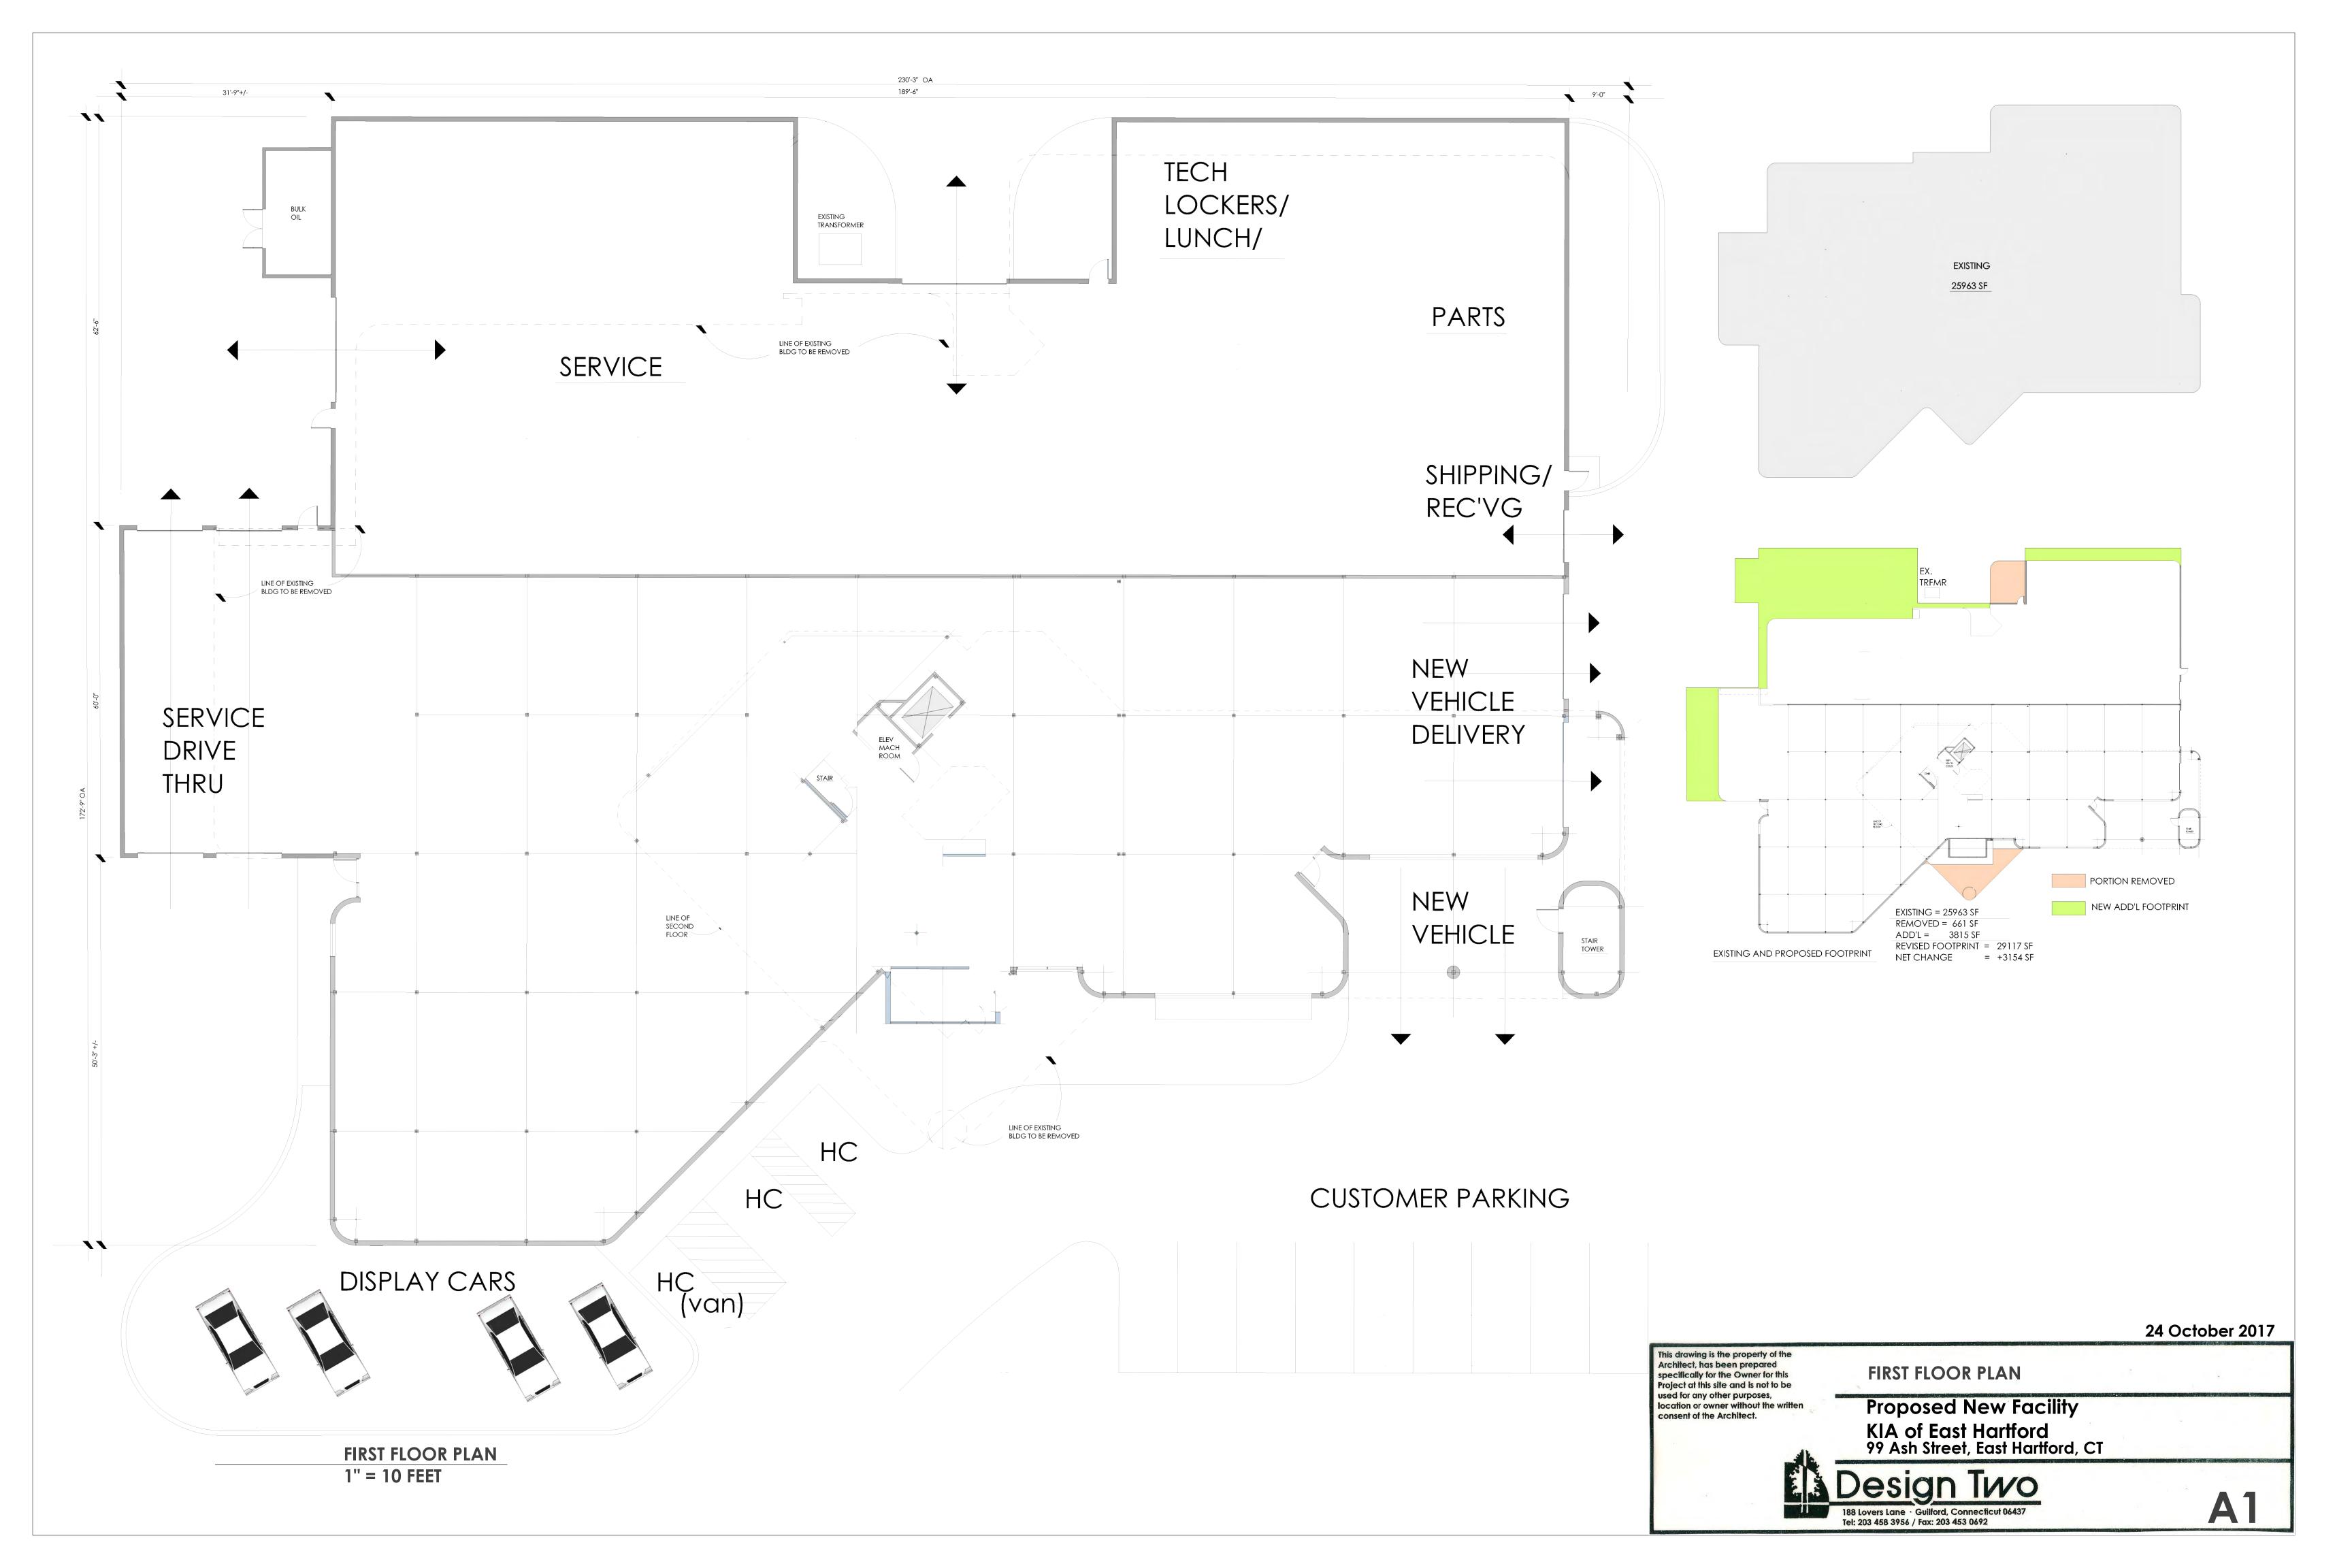





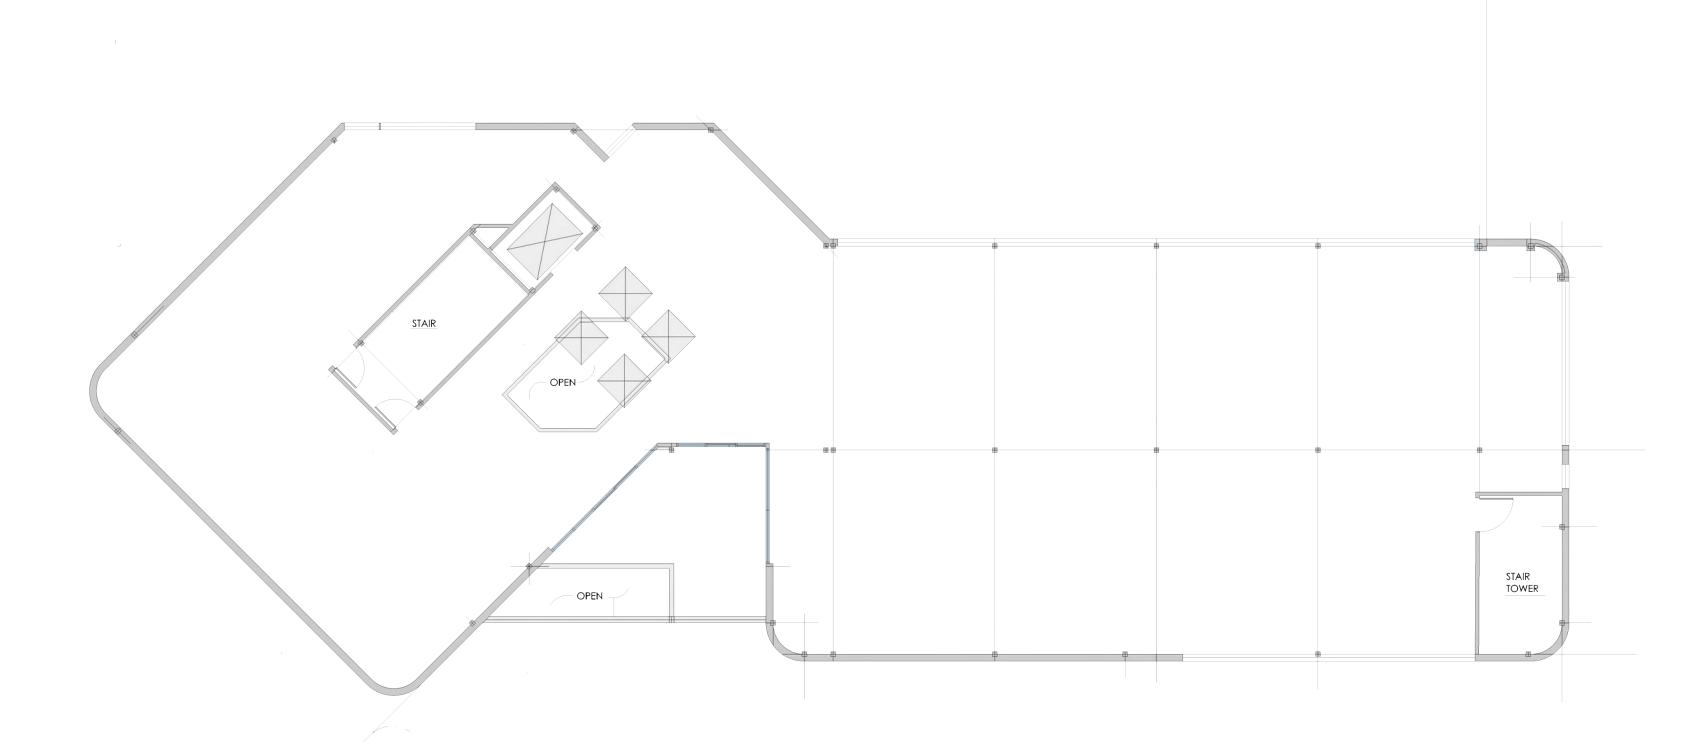

1" = 10 FEET

Signs shown are illustrative only pending separate sign application

24 October 2017

EXISTING SECOND FLOOR PLAN

This drawing is the property of the Architect, has been prepared specifically for the Owner for this Project at this site and is not to be used for any other purposes, location or owner without the written consent of the Architect.

SECOND FLOOR PLAN

Proposed New Facility KIA of East Hartford 99 Ash Street, East Hartford, CT



