

## Official Receipt Date:

---

**\*COMPLETE SECTION ON PAGE 2 OR 3**

- ☐ **SOIL EROSION AND SEDIMENTATION** - Cumulative disturbed area (sq. ft.): \_\_\_\_\_

PROPERTY ADDRESS: 400 Main Street ZONE: DDD1

ASSESSORS MAP AND LOT: 20-45 PARCEL SIZE (ACRES OR SQ. FT.): 788.82

PROJECT NAME: Pratt & Whitney Sanitary Sewer Force Main

**PROJECT DESCRIPTION (ATTACH ADDITIONAL SHEETS IF NEEDED):**

The project includes the installation of approximately 2,000 feet of new sanitary force main. The trenching for the new force main will be approximately 4 feet wide by 5 feet deep and will cross grass areas and paved areas. A portion of the work is within a flood hazard zone and upland review area; no work will be conducted in the wetlands. Erosion control will be installed prior to the start of construction. All areas disturbed by construction will be restored to match existing conditions.

☐ CHECK IF PRIMARY CONTACT

OWNER OF RECORD: United Technologies Corporation/Pratt & Whitney

OWNER ADDRESS: 400 Main Street, East Hartford, CT

OWNER PHONE: 860-557-3268 OWNER EMAIL: Erich.Uhlan@pw.utc.com

OWNER SIGNATURE: Erich Uhlan PRINT NAME: Erich Uhlan

The undersigned owner hereby authorizes: **(1)** this application, and **(2)** the Planning and Zoning Commission and Town of East Hartford staff the right to enter upon the property for the purposes of inspection associated with this application.

☐ CHECK IF PRIMARY CONTACT

- ☒
- CHECK IF APPLICANT IS SAME AS PROPERTY OWNER

APPLICANT: \_\_\_\_\_

APPLICANT ADDRESS: \_\_\_\_\_

APPLICANT PHONE: \_\_\_\_\_ APPLICANT EMAIL: \_\_\_\_\_

APPLICANT SIGNATURE: \_\_\_\_\_ PRINT NAME: \_\_\_\_\_

☐ CHECK IF PRIMARY CONTACTFIRM: Loureiro Engineering Associates, Inc

PHONE: 860-747-6181

CONTACT PERSON: Chris Winter

EMAIL: [ccwinter@loureiro.com](mailto:ccwinter@loureiro.com)

**- COMPLETE ONLY THE SECTIONS THAT APPLY TO YOUR APPLICATION TYPE -**

**A. SPECIAL USE PERMIT**

**(ATTACH ADDITIONAL SHEETS IF NEEDED)**

1) Applicable Section of the Zoning Regulations: \_\_\_\_\_

2) Describe how the proposed Special Use Permit relates to the Plan of Conservation and Development:

3) Describe how the proposed Special Use Permit will benefit the Town of East Hartford:

**B. FLOOD HAZARD ZONE – MAJOR DEVELOPMENT OR MINOR DEVELOPMENT**

1) Name of associated watercourse: Pewterpot Brook

2) Total amount of land (in sq. ft.) to be affected within the:

a. Flood Hazard Zone: 888 sq. ft.

b. Floodway: 58 sq. ft.

c. Floodway fringe: 830 sq. ft

3) Enumerate methods of compliance with Sections 601.10, 601.11, and 601.12 of the Zoning Regulations:


Areas disturbed by construction will be restored to match existing conditions with no changes to flood storage or conveyance. The new piping will be constructed using watertight joints to eliminate infiltration and exfiltration.

# PRATT & WHITNEY

## SANITARY FORCE MAIN DESIGN

400 MAIN STREET  
EAST HARTFORD, CONNECTICUT

AUGUST 12, 2019

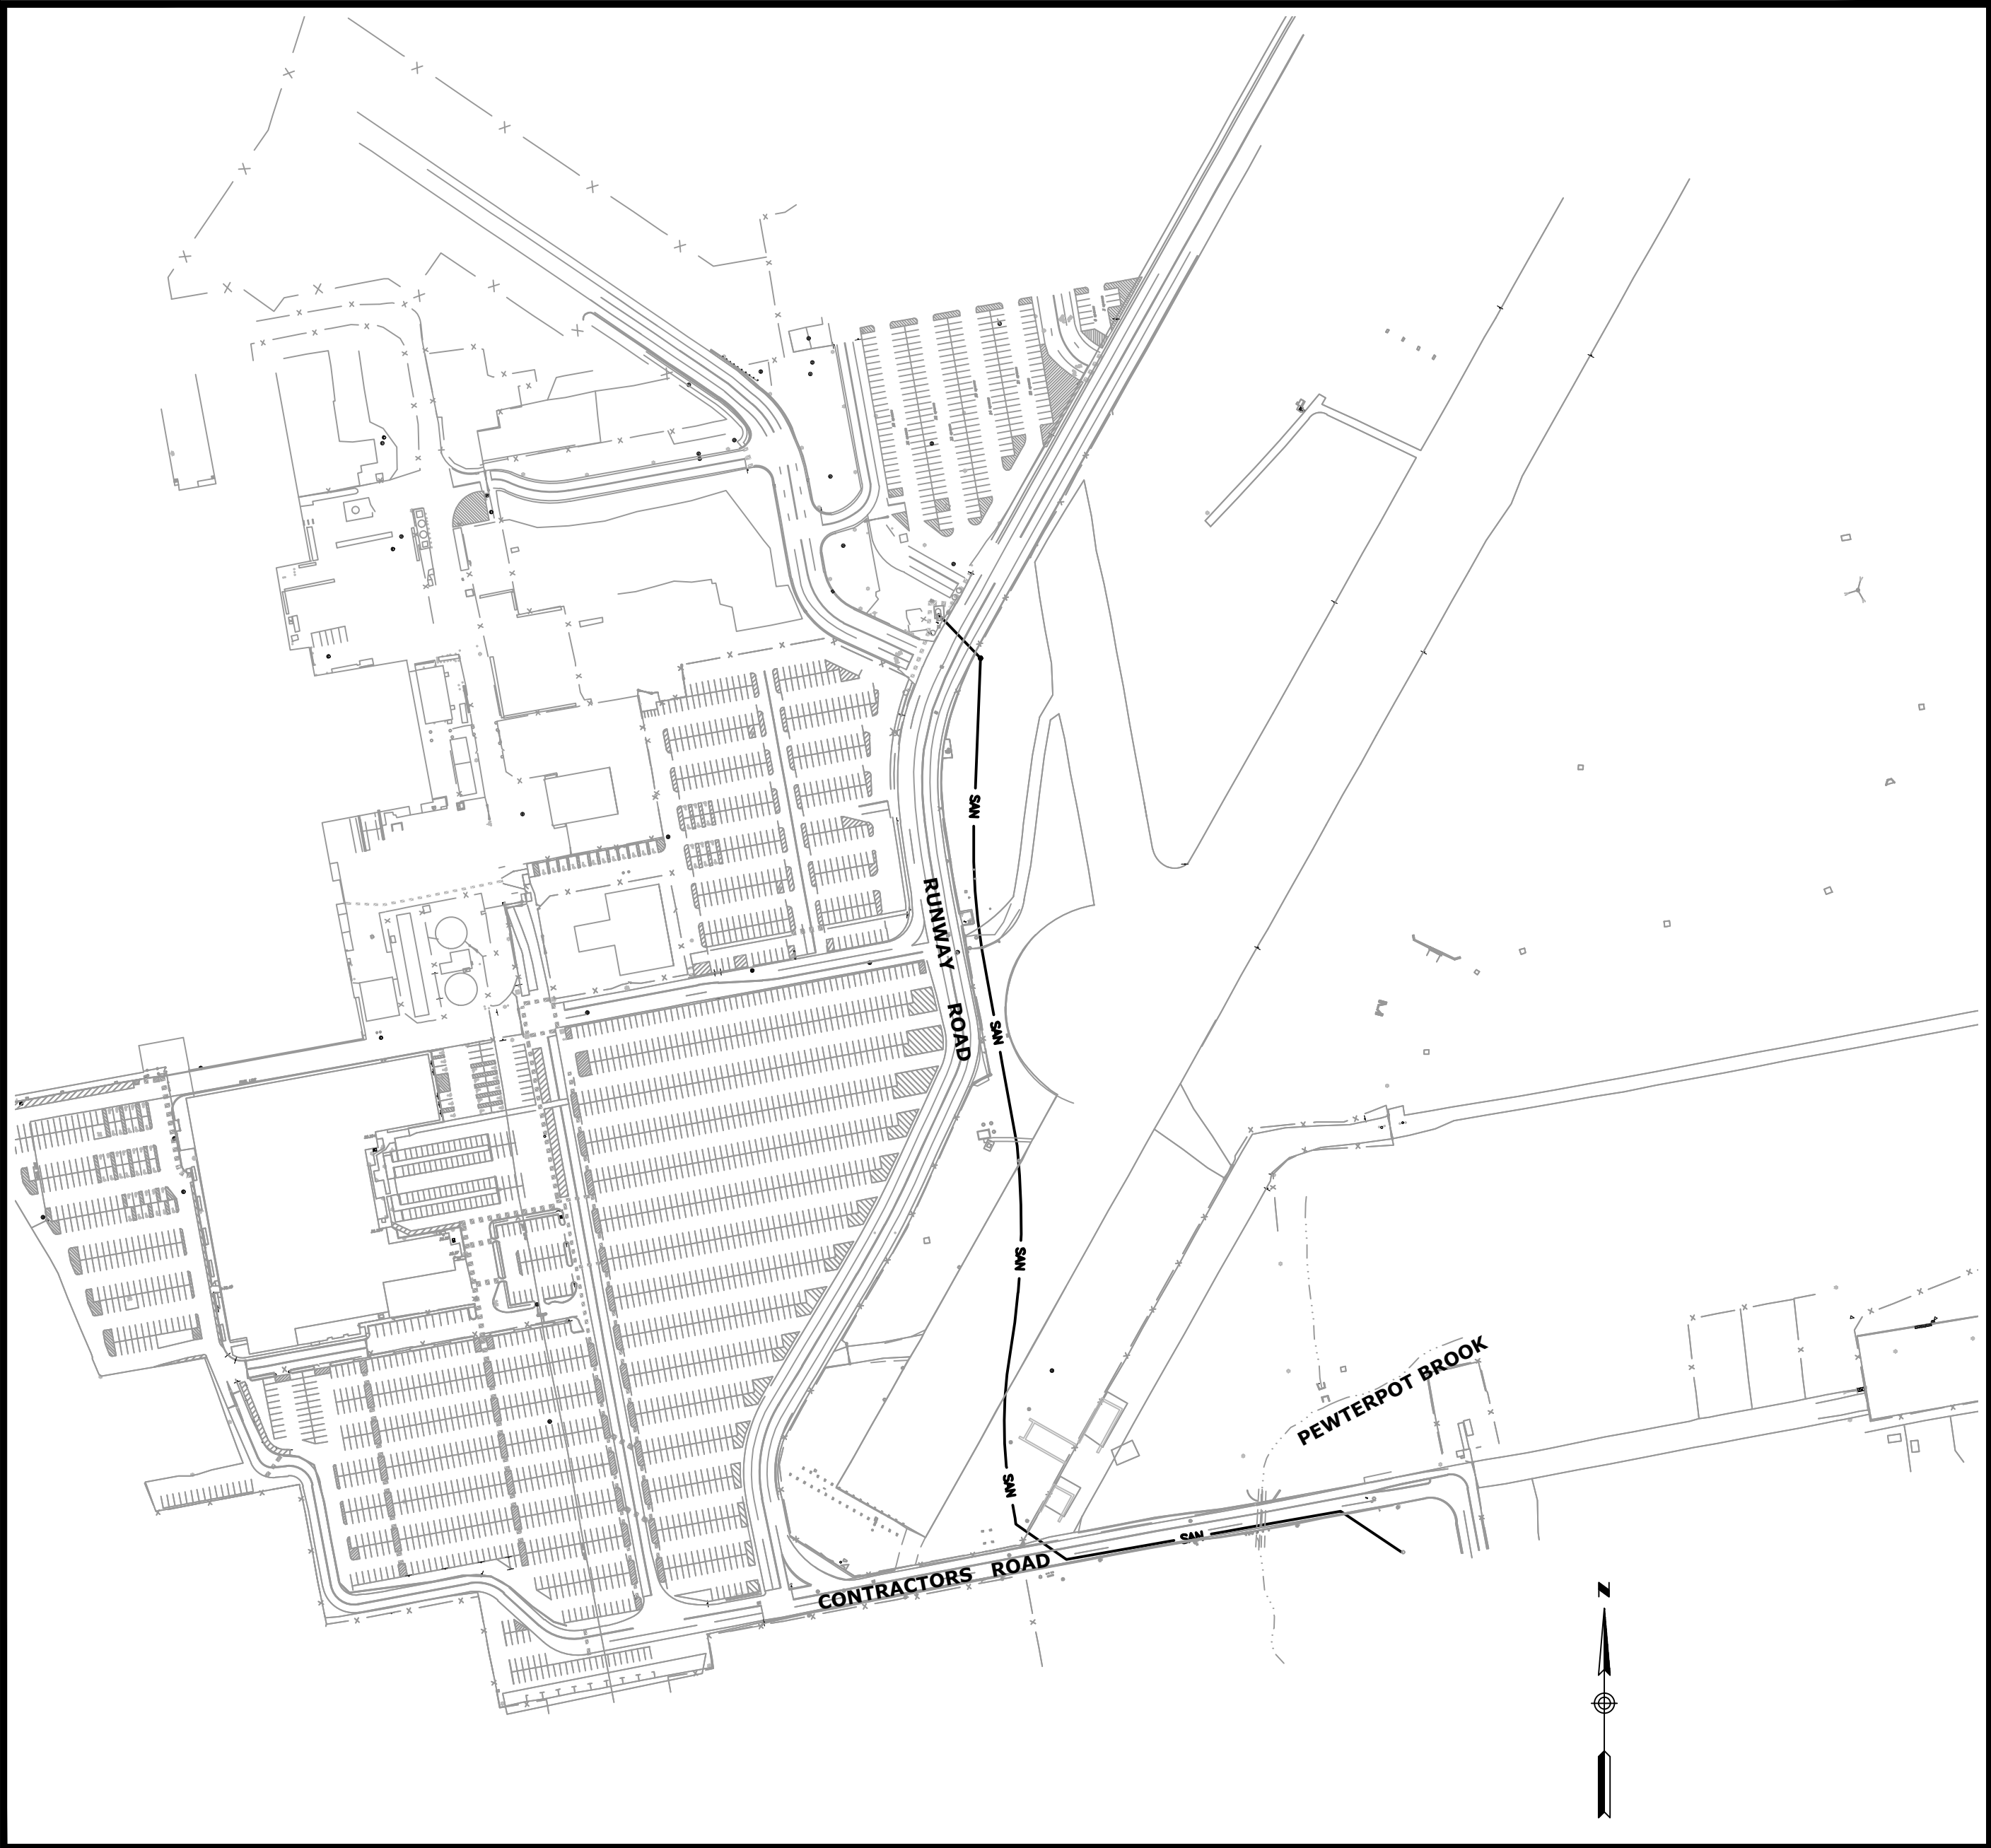

LOCATION MAP  
SCALE: 1" = 1,500±

### DRAWING INDEX

	COVER SHEET
EX	EXISTING CONDITIONS
S	FORCE MAIN LAYOUT
DE	SITE DETAILS
SESC	SOIL EROSIONS AND SEDIMENT CONTROL DETAILS
SP	TECHNICAL SPECIFICATIONS


Pratt & Whitney  
400 Main Street  
East Hartford, CT 06118

Prepared By:  
Engineer:



Loureiro Engineering Associates, Inc.  
100 Northwest Drive • Plainville, Connecticut 06062  
Phone: 860-747-6181 • Fax: 860-747-8822  
An Employee Owned Company • [www.Loureiro.com](http://www.Loureiro.com)  
Engineering • Construction • EH&S • Energy  
Waste • Facility Services • Laboratory







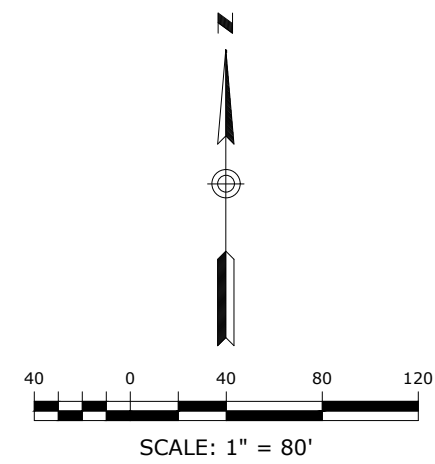



1. SURVEY COMPLETED BY LOUREIRO ENGINEERING ASSOCIATES ON APRIL 19, 2019.
2. WETLAND DELINEATION ADAPTED FROM TOWN OF EAST HARTFORD "INLAND WETLANDS AND WATERCOURSE" MAP, DATED APRIL 29, 2005 BY THE TOWN OF EAST HARTFORD ENGINEERING DIVISION.
3. EXISTING FORCE MAIN LOCATION WAS ADAPTED FROM PLANS TITLED, "AS-BUILT SITE UTILITIES" SHEETS U-2 AND U-3, DATED AUGUST 1, 1966 BY JAMES S. MINGES & ASSOCIATES FOR PRATT & WHITNEY AIRCRAFT.
4. ASSUMED MANHOLE LOCATIONS, APPROXIMATE DRAINAGE SYSTEM LOCATIONS, AND PIPE INVERTS AND SIZES WERE ADAPTED FROM "STORM DRAINAGE ANALYSIS, UNITED TECHNOLOGIES CORP. PRATT & WHITNEY STORM SEWER SYSTEM", DATED AUGUST 6, 2008 BY LOUREIRO ENGINEERING ASSOCIATES, INC FOR UNITED TECHNOLOGIES CORP. PRATT & WHITNEY.

<p><b>EXISTING CONDITIONS</b></p> <p><b>SANITARY FORCE MAIN DESIGN</b>  <b>400 MAIN STREET, EAST HARTFORD, CONNECTICUT</b></p> <p><b>PRATT &amp; WHITNEY</b>  <small>PREPARED FOR:</small></p>		<p>SCALE  <b>1" = 80'</b></p> <p>CORN. NO.  <b>68P99.97</b></p> <p>DRAWN BY  <b>TRW</b></p> <p>DATE  <b>8/12/2019</b></p> <p>APPROVED BY  <b>CCW</b></p> <p>DATE  <b>8/12/2019</b></p>	<p><b>Loureiro</b>          Engineering Associates, Inc.          Water • Facility Services • Laboratory</p> <p><b>Loureiro Engineering Associates, Inc.</b>          100 Northwest Drive • Plainville, Connecticut 06062          Tel: 860.261.1100 • Fax: 860.261.1101 • Email: sales@loureiro.com          An Employee Owned Company • www.Loureiro.com</p> <p>© Loureiro Engineering Associates, Inc.          All rights reserved 2019</p>	<p>STAMP</p>	<p>REV.</p> <p>DATE</p> <p>DESCRIPTION OF REVISION</p>
SHEET NO. 1	DRAWING NO. 1	NO. OF SHEETS 5			

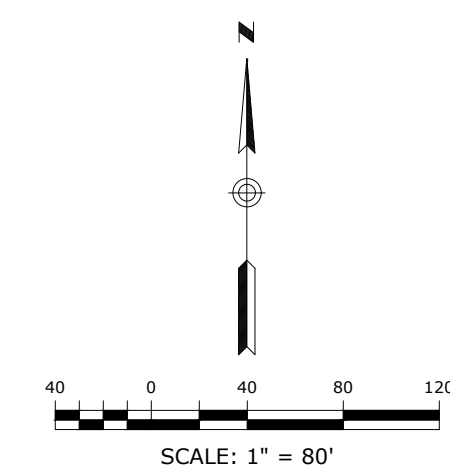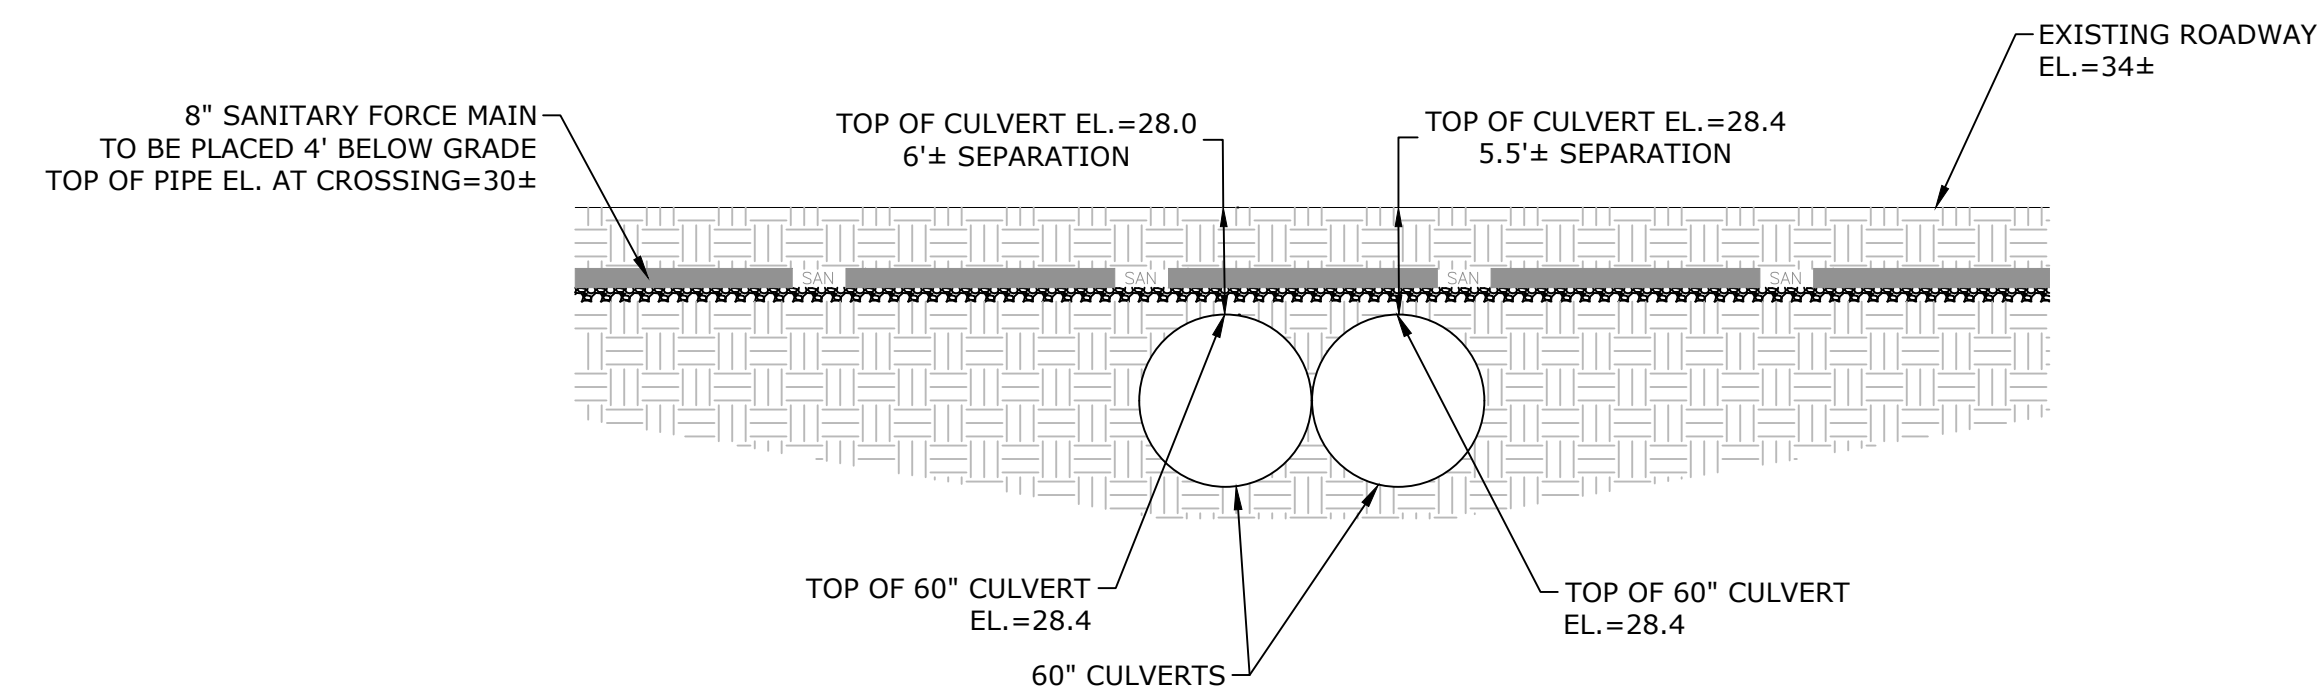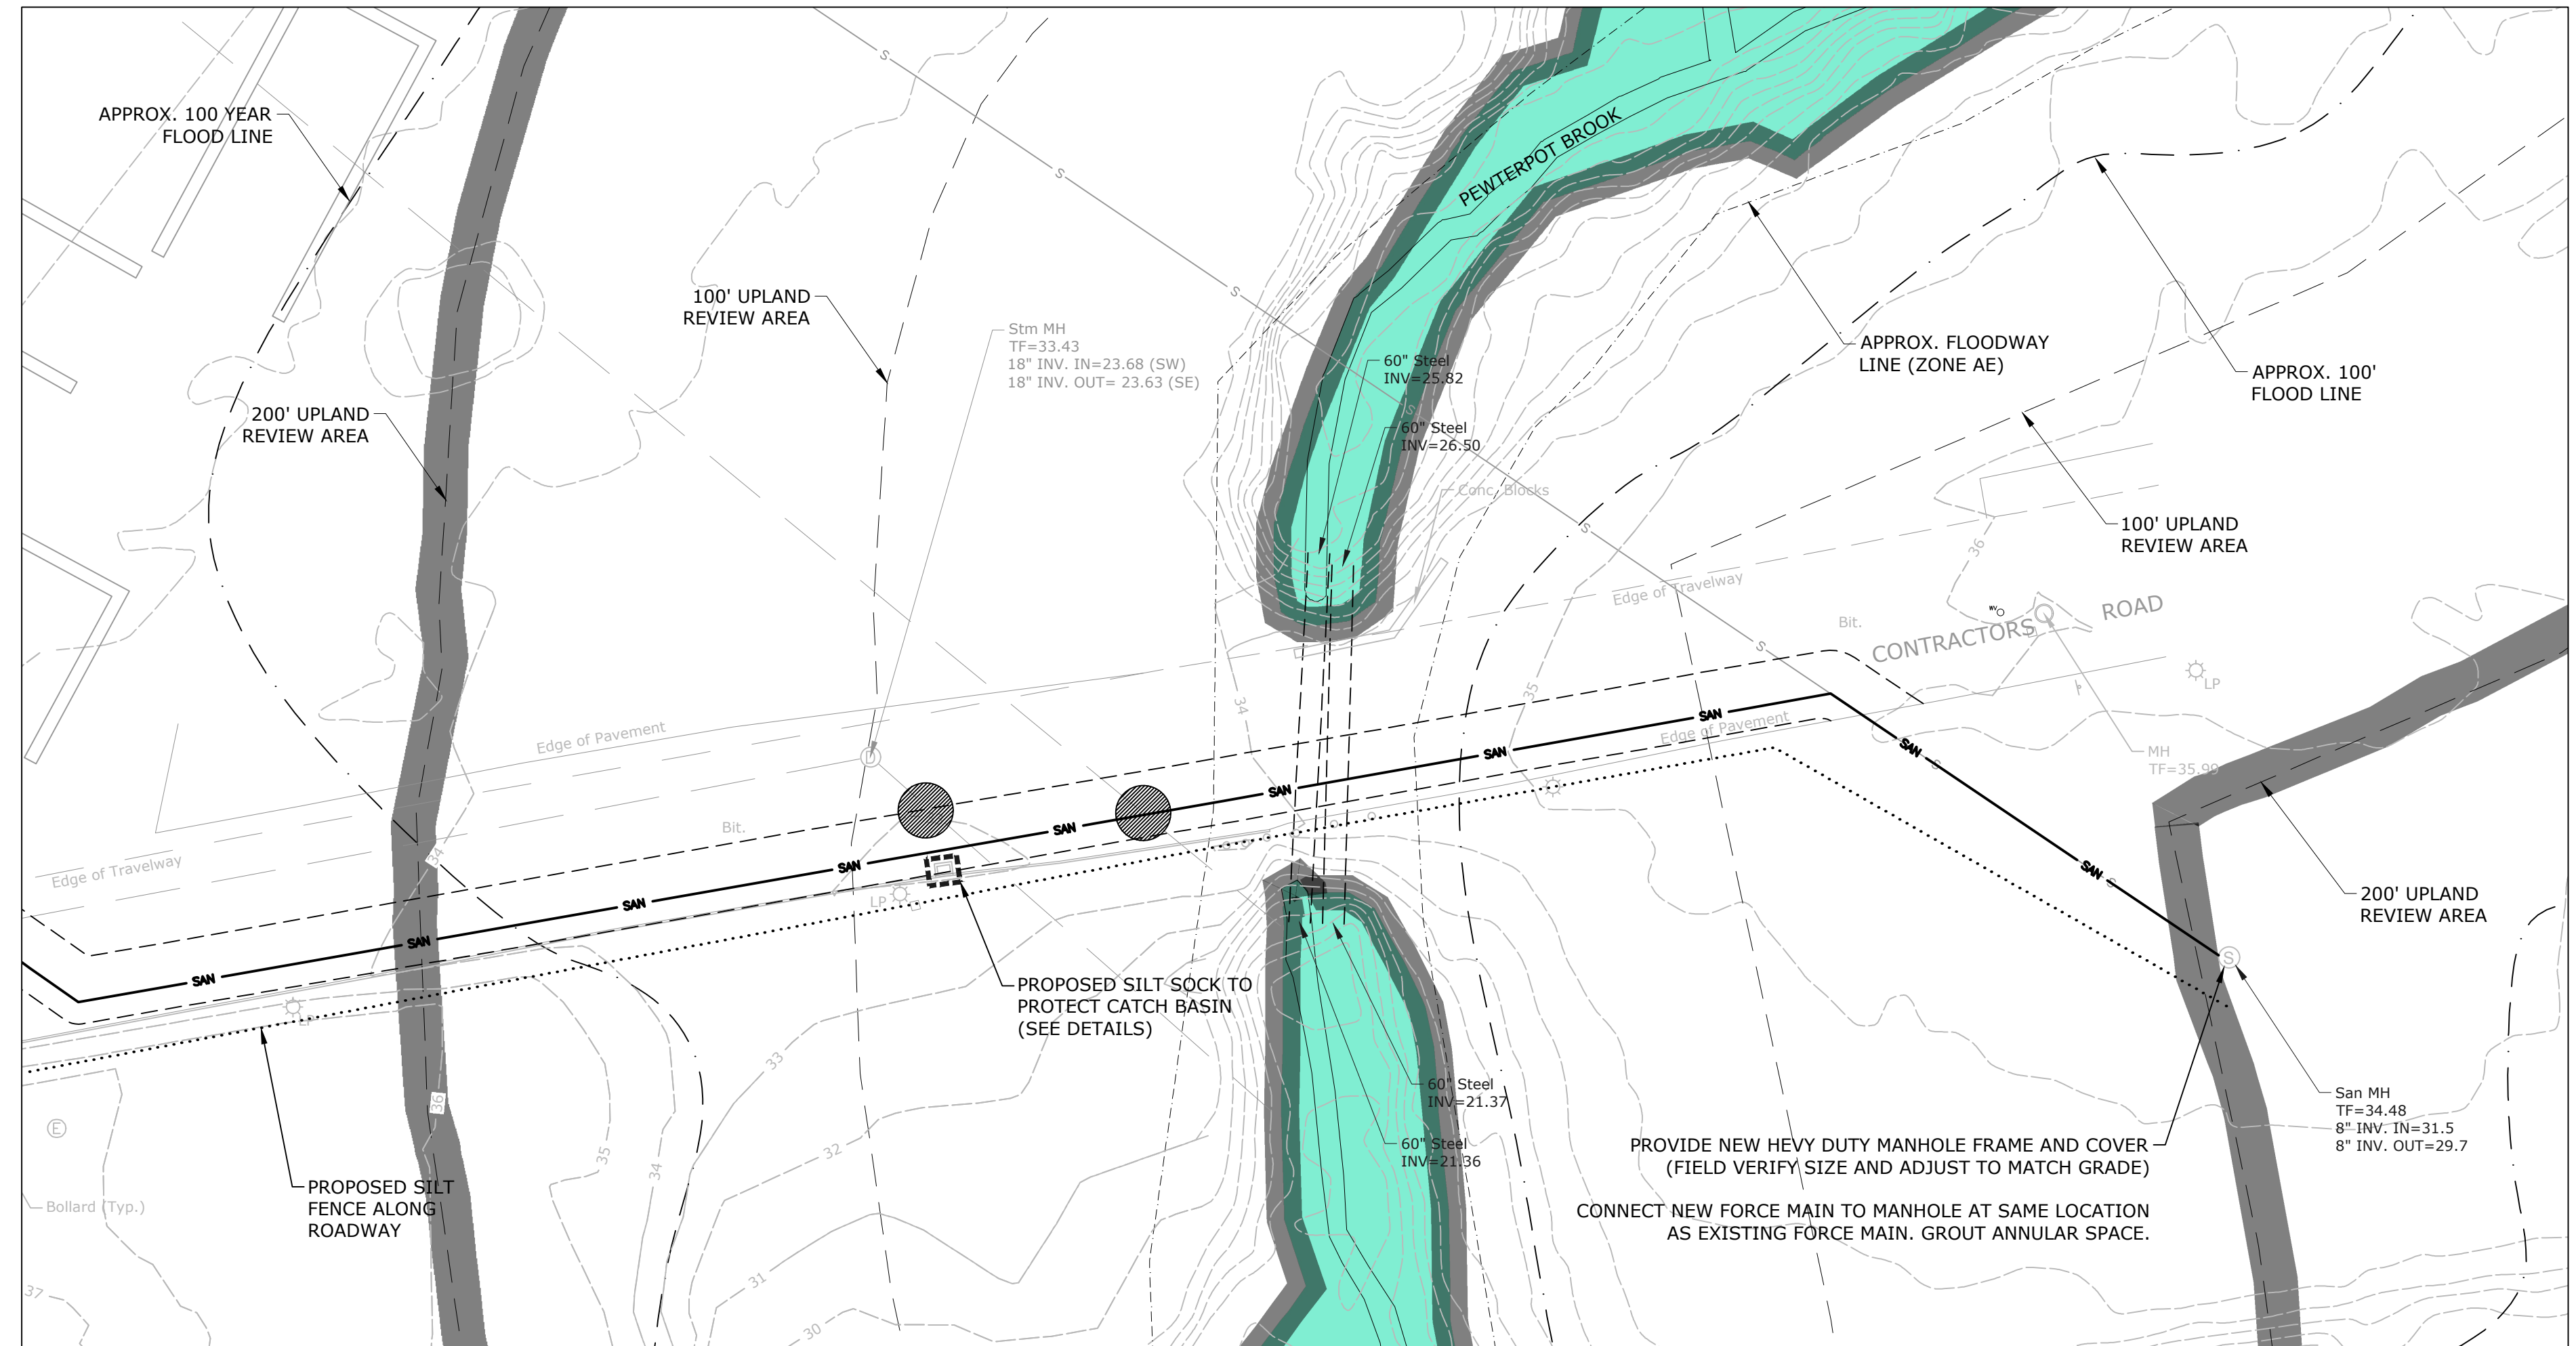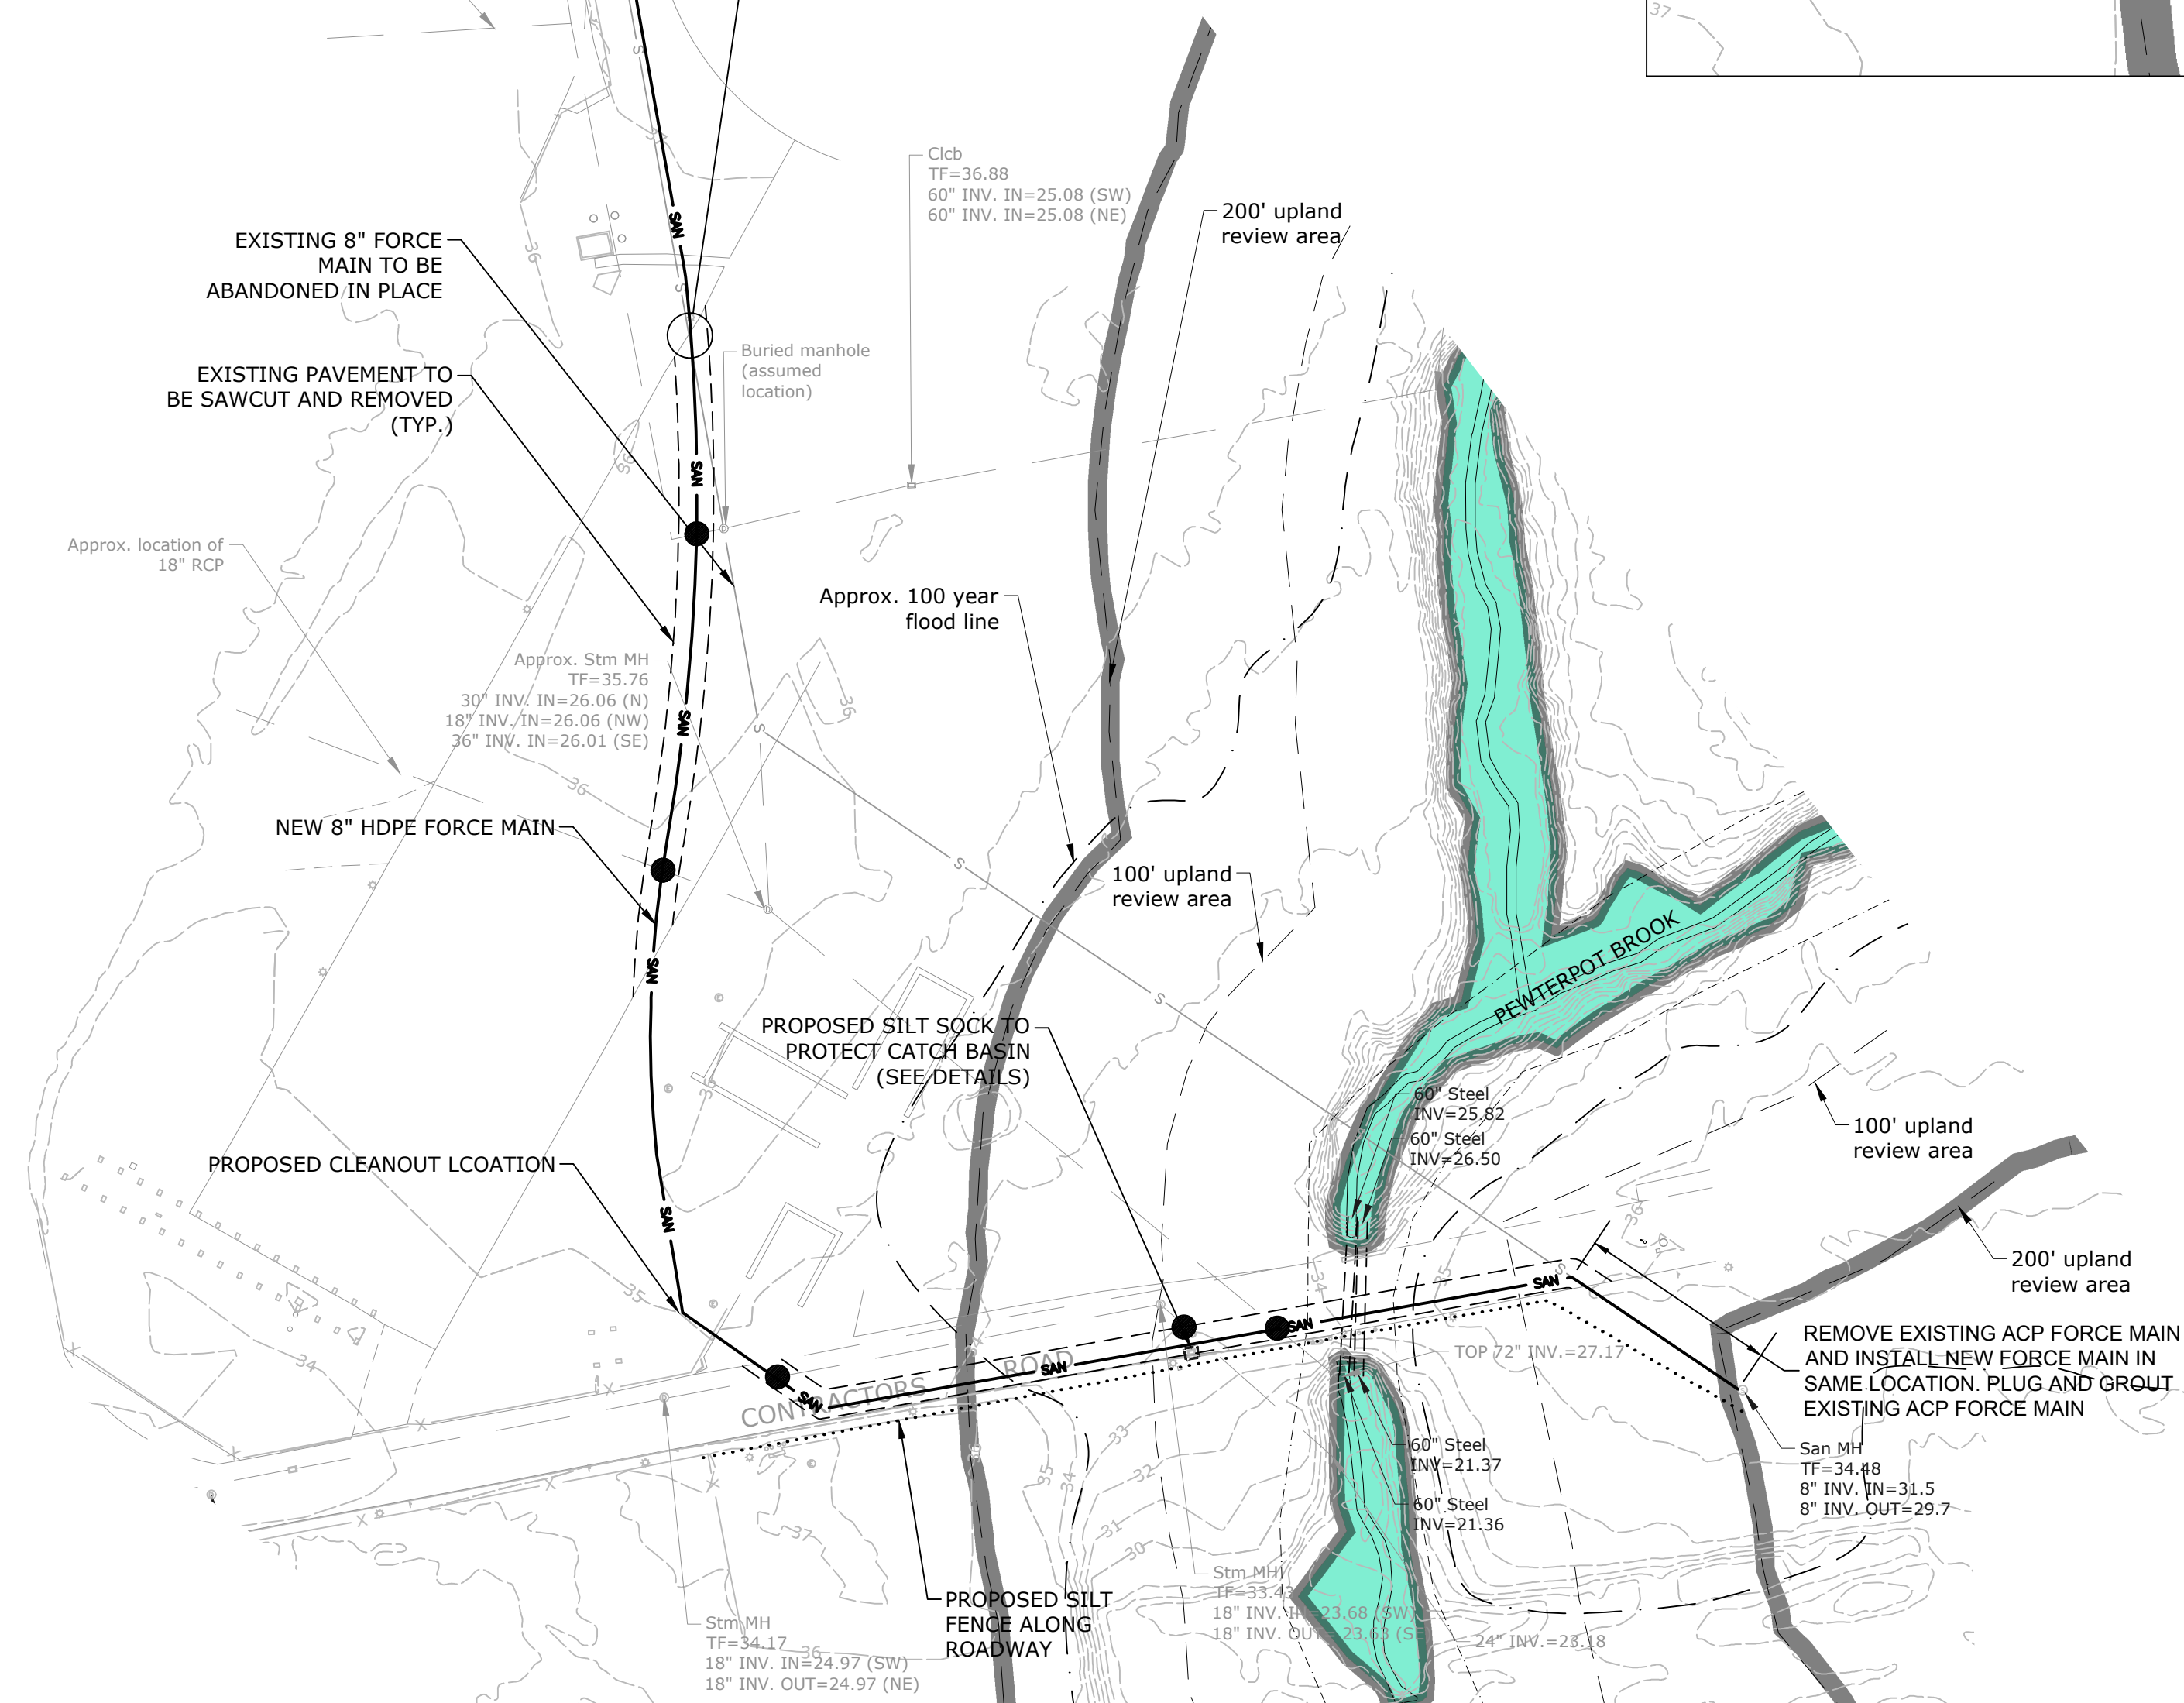

[illegible]




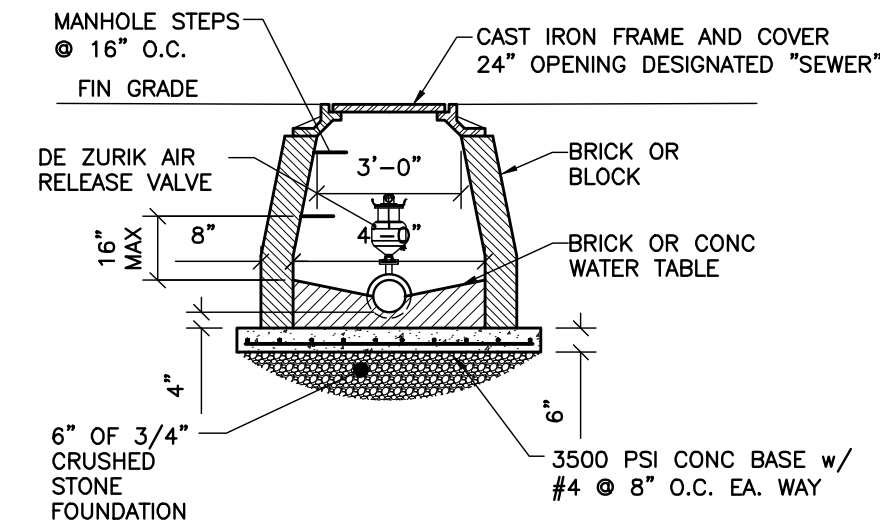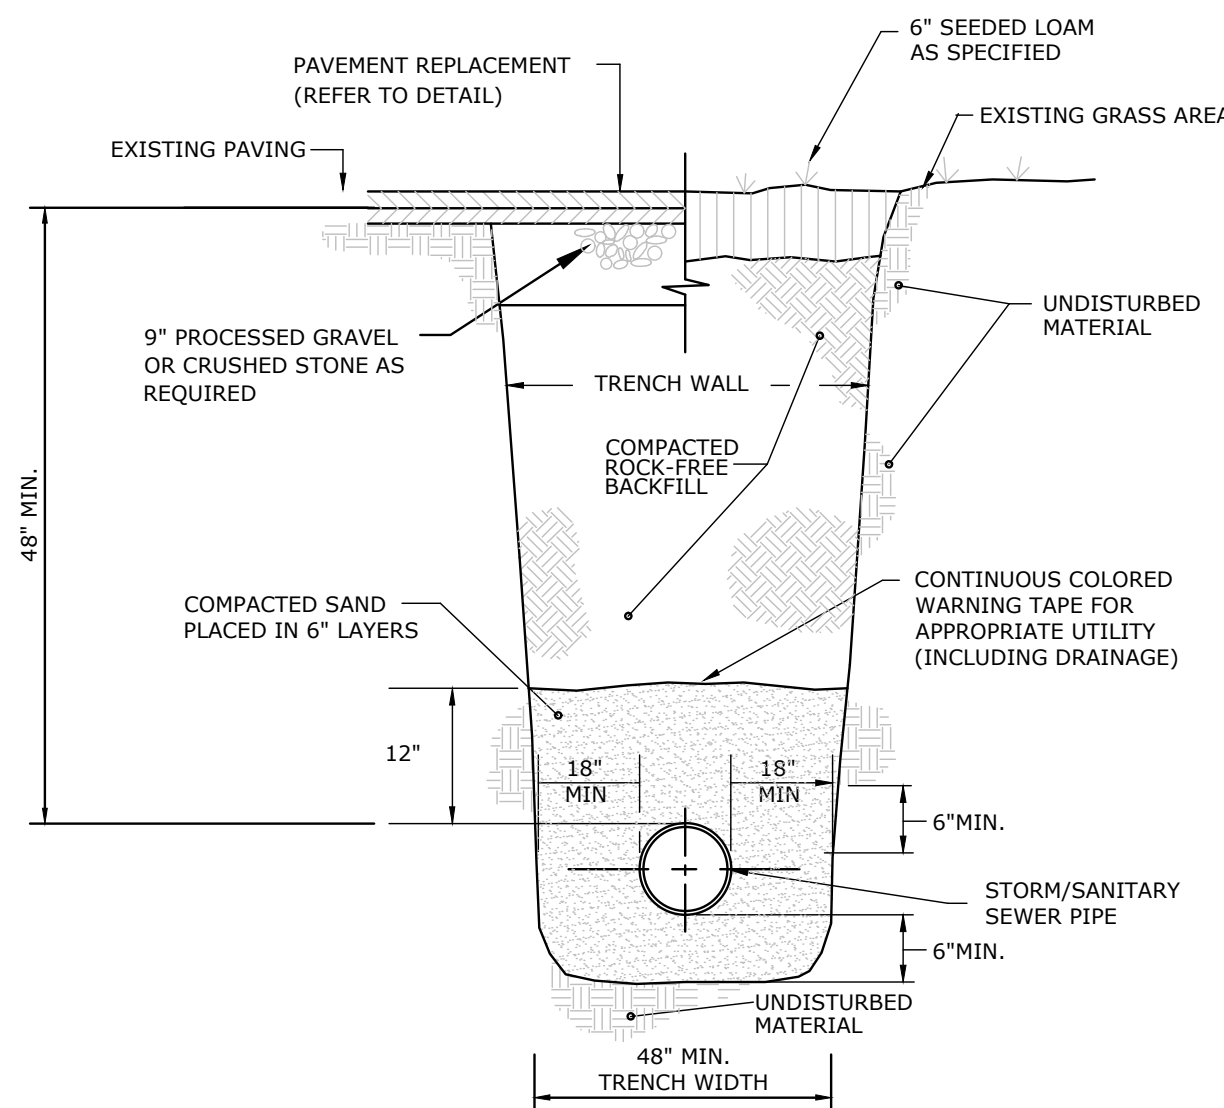

NOTES:

1. SEE STATE AND/OR LOCAL HIGHWAY DEPARTMENT SPECIFICATIONS FOR ADDITIONAL PAVING REQUIRED WHEREVER APPLICABLE.
2. DEEP FOUNDATIONS: WHERE SPECIAL DEEP FOUNDATIONS ARE REQUIRED, BECAUSE OF VERY SOFT SOIL FOUNDATION, CRUSHED STONE OR PROCESSED GRAVEL SHALL BE USED TO A POINT 24" DEEPER THAN FLOW LINE OF PIPE. ADDITIONAL FOUNDATION DEPTH BELOW THIS POINT MAY BE OTHER SELECTED MATERIAL, AS SPECIFIED AND AS REQUIRED BY THE ENGINEER IN THE FIELD.

## SCALE: NONE

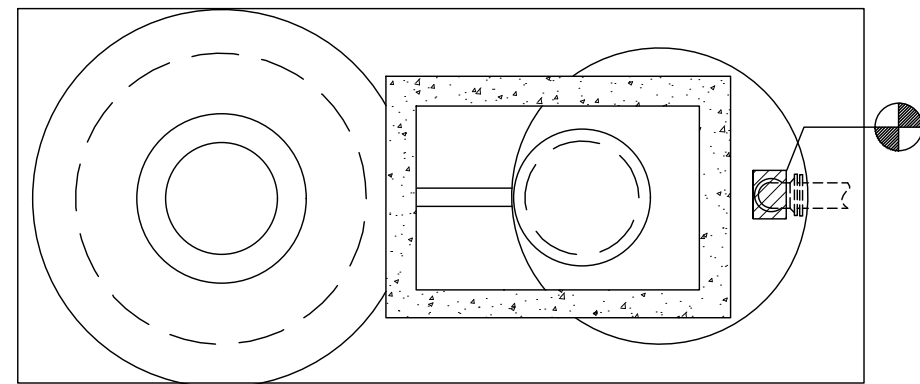

DE ZURIQ PEC ECCENTRIC PLUG VALVE, SEMI-STEEL BODY, MECH. JOINT WITH ROAD BOX AND EXTENDED WORM GEAR ACTUATING NUT

REPLACE EXISTING PIPING TO PROPOSED SANITARY LINE.

## PUMP HOUSE FORCE MAIN REPLACEMENT DETAIL

- NOTE:
1. EXISTING PUMP HOUSE DETAIL REFERENCED FROM PLANS TITLED, "SITE UTILITIES DETAILS MATERIAL CENTER BUILDING" SHEETS U-6, REVISED NOVEMBER 8, 1965 BY JAMES S. MINGES & ASSOCIATES FOR PRATT & WHITNEY AIRCRAFT.
  2. THE EXISTING PUMP HOUSE DETAIL SHOWS THE APPROXIMATE LOCATION AND CONFIGURATION. THE PUMP HOUSE HAS BEEN ALTERED TO INCLUDE ABOVEGRDND PUMPS, ENCLOSURE AND BYPASS PIPING. CONTRACTOR SHALL PROVIDE A TEST PIT TO VERIFY LOCATION AND CONFIGURATION OF CONNECTION POINT.

[illegible]



SOIL EROSION AND SEDIMENT CONTROL NOTES

GENERAL PROVISIONS

All applicable regulations and requirements of the State of Connecticut Department of Energy & Environmental Protection (DEEP) and the local Inland Wetlands Commission shall be adhered to including the placement of the proposed sedimentation/detention basin and SESC barriers as depicted on this plan and as specified herein. When the construction work is completed, the Contractor shall remove all sediment from the sedimentation/detention basin and restore the natural drainage areas affected by his operations to their original condition unless otherwise directed by the Engineer.

Prior to construction , all SESC barriers should be placed to confine sediment as shown on drawings and where otherwise required based on the Contractor's means/methods and construction sequencing. All SESC barriers shall be left in place and maintained until the work has been completed and surfaces stabilized.

It shall be the responsibility of the Contractor to monitor the condition of the SESC structures. If the effectiveness or integrity of the structures is found to be insufficient or if the structures are damaged in any way, the Contractor shall make whatever repairs are necessary to ensure that proper erosion control is maintained. Monitoring of the erosion control structures is particularly important in the areas where excavation or construction is taking place or following periods of rainfall. All repairs of erosion control structures shall be made by the Contractor as soon as the damage is discovered. If additional SESC control structures are necessary to minimize erosion and sedimentation, as determined in the field, the Contractor shall install said additional structures as required at no extra cost to the Owner or the Engineer.

SPECIFIC PROVISIONS


In addition to the above general provisions, the Contractor shall comply with the following special requirements:

- Land disturbance shall be kept to a minimum; restabilization shall be scheduled as soon as practicable following construction. Project sequencing will be necessary to minimize SESC control liabilities. The Contractor shall sequence his operations so as to provide manageable work areas with limited opportunity for soil erosion to occur.
- All graded areas are to be loamed and seeded as soon as possible after construction work is completed. Interim seeding, mulching and/or erosion control blankets may be required throughout construction for stabilization of disturbed areas. All other areas affected by construction and not to be regraded or filled are to be restored to original grade and seeded as shown on the site drawing.
- For specific details on the design, application and installation of the SESC structures the Contractor shall refer to the Connecticut Guidelines for Soil Erosion and Sediment Control, dated May 2002, as amended or otherwise replaced.
- The Contractor shall be fully responsible for ownership of all soil erosion and sediment controls as necessary to protect the project site. During the progress of construction, interim erosion controls may be necessary based on the Contractors means, methods and sequencing. The erosion control measures presented on these plans represent the minimum controls deemed necessary based on the expected final project grades and features. Interim measures required to stabilize the site during construction shall be installed by the Contractor as needed based upon his assessment of the site through his own site inspections and observations.
- Fabric for SESC barriers shall consist of woven polypropylene, 36" in width and fastened to hardwood posts with three, one inch wide crown staples. Posts shall be of sound hardwood, forty eight inches (48") in length with a minimum cross section of 1.125 square inches. Staked hay bales may be substituted for silt fence. All SESC barriers shall be installed as shown on this drawing and at the toe of all slopes located down gradient of the construction work.
- Sediment removed from SESC barriers and sediment/detention basin ID shall be disposed of in a manner which is consistent with the intent of the plan.
- Groundwater sampling and dewatering shall meet DEEP standards, if required. Groundwater is to be sampled prior to discharging stored water.
- The Contractor shall use approved methods and materials for prevention of dispersion of dust.
- The Contractor shall inspect all erosion control measures daily during construction and after each significant rain storm event. In the event that a rain event occurs and the Contractor provided SE&SC controls fail to maintain the site in a stabilized condition, the Contractor shall be fully responsible for any and all remediation, mitigation or other damage that may occur.

CONSTRUCTION SEQUENCE NOTES

Low Impact Construction practices should be adopted to further mitigate erosion and sedimentation.


- Utility survey of proposed trenched areas should be completed prior to construction.
- Install perimeter and catch basin SE&SC. Clear any areas of brush upon land surface, as needed, to facilitate the construction activities defines. Install perimeter SE&SC as notes on plan.
- Trench proposed pipe route per plans.
- Excavate culvert crossing to elevation shown on plans. Contractor shall be responsible for any damage done to the culvert.
- Connect force main to existing submarine, pump house, with new valve as specified in details.
- Contractor shall follow directions on handling existing force main where indicated on plan.
- Install new force main pipe in existing manhole at same elevation. Existing frame and cover to be replaced.
- Trench to be backfilled to existing grade along the entire pipe route.
- Any changes to routing or installation shall be approved by Pratt & Whitney and the engineer.

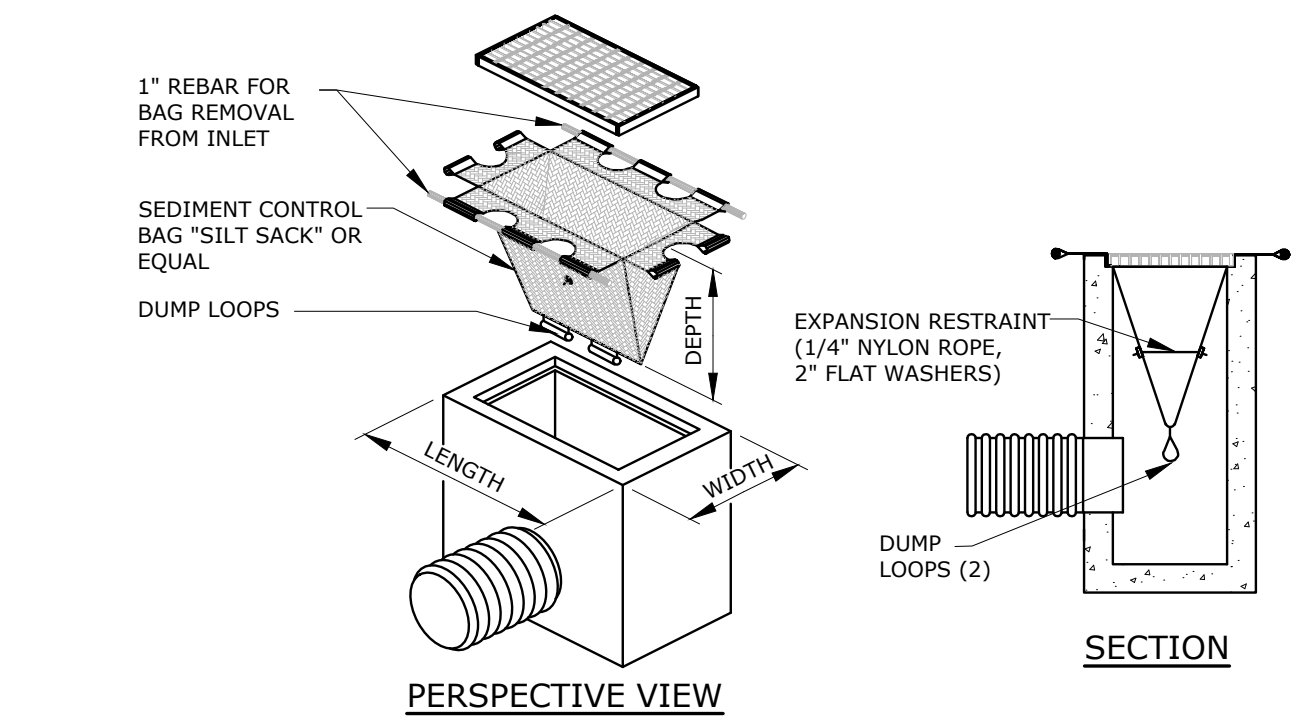

- NOTES:
- THE CONTRACTOR IS RESPONSIBLE FOR PROVIDING THE CORRECT SIZE DEVICE FOR EACH INLET. FOR NON-STANDARD CATCH BASINS AND INLETS, THE CONTRACTOR SHALL MEASURE DIMENSIONS IN THE FIELD AND ORDER THE APPROPRIATE SIZE(S).
  - THE INLET SEDIMENT CONTROL DEVICE SHALL BE OF HIGH FLOW DESIGN (200 GAL/MIN/FT), AS PER THE MANUFACTURER'S SPECS.
  - THE SEDIMENT CONTROL DEVICE SHALL BE INSPECTED DAILY BY THE CONTRACTOR AND CLEANED AND MAINTAINED A MINIMUM ONCE PER MONTH OR WITHIN THE 48 HOURS FOLLOWING A STORM EVENT. THE FILTER SHALL BE REPLACED OR CLEANED WHEN THE BAG BECOMES HALF FULL. THE FILTER SHALL BE CLEANED IN A MANNER WHICH ENSURES THAT ALL SEDIMENT REMAINS ON SITE.
  - SUBSTITUTION OF A SHEET OF FILTER FABRIC PLACED OVER THE OPENING OF THE INLET IS NOT APPROVED.
  - RECESSED CURB INLET CATCH BASINS MUST BE BLOCKED WHEN USING FILTER FABRIC INLET SACKS, SIZE OF FILTER INLET SACK TO BE DETERMINED BY MANUFACTURER.
  - THE FILTER DEVICE SHALL BE MANUFACTURED BY ACF ENVIRONMENTAL OR APPROVED EQUAL.

CATCH BASIN FILTER (SILT SACK)


SCALE: NONE

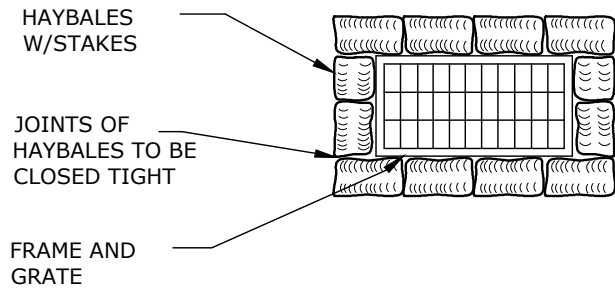

- NOTE:
- CATCH BASIN GRATES TO BE WRAPPED W/MARAFI 500 FILTER CLOTH OR APPROVED EQUAL AND BULKHEADED WITH HAYBALES IMMEDIATELY PRIOR TO CONSTRUCTION

SEDIMENT BARRIER AT CATCH BASIN


SCALE: NONE

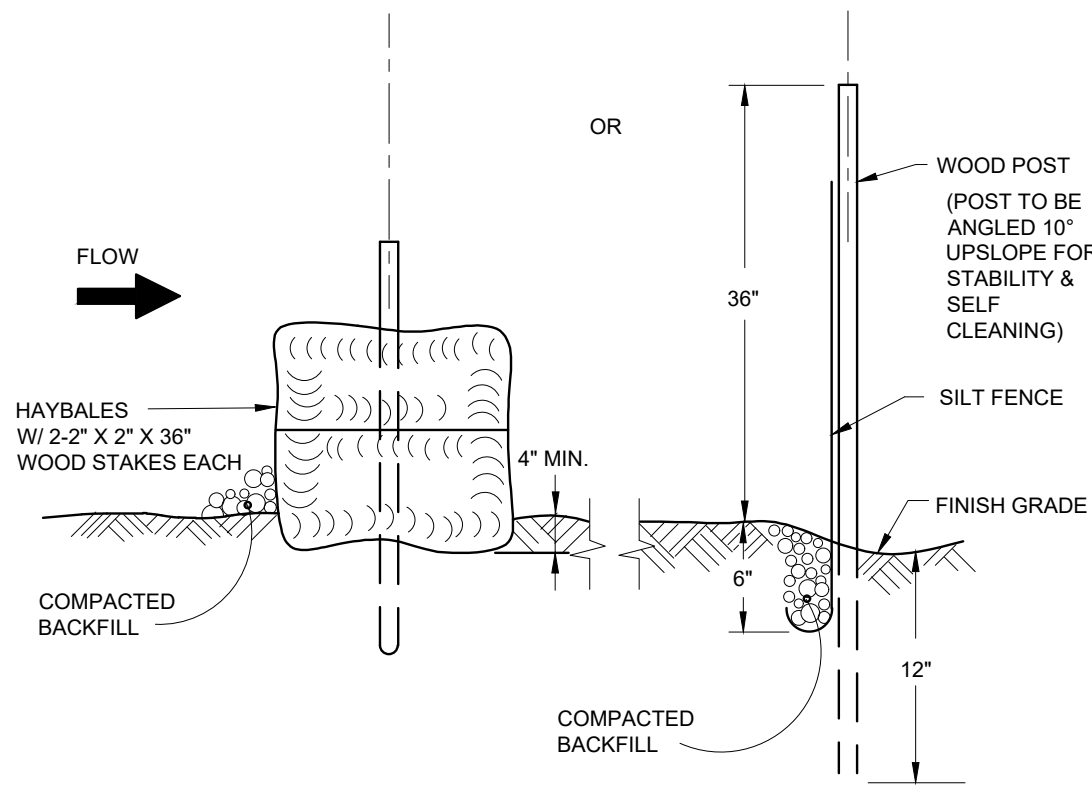

TYPICAL SEDIMENT BARRIER DETAIL

SCALE: NONE

- INSTALLATION NOTES FOR HAY BALES:
- PLACE HAY BALES ON CONTOUR AND WITH LAST HAY BALES UPSLOPE TO THAT TOP OF LAST SEVERAL HAY BALES ARE HIGHER THAN LINE OF HAY BALES.
  - EXCAVATE TRENCH 4" MIN. AND PLACE FILL UPSLOPE OF TRENCH.
  - PLACE HAY BALE AND STAKE FIRST STAKE AT ANGLE TOWARDS FIRST BAKE. STAKES ARE 18" MIN. INTO GROUND.
  - WEDGE LOOSE HAY BETWEEN BALES.
  - BACKFILL & COMPACT EXCAVATED FILL ALONG UPHILL SIDE OF HAY BALE.

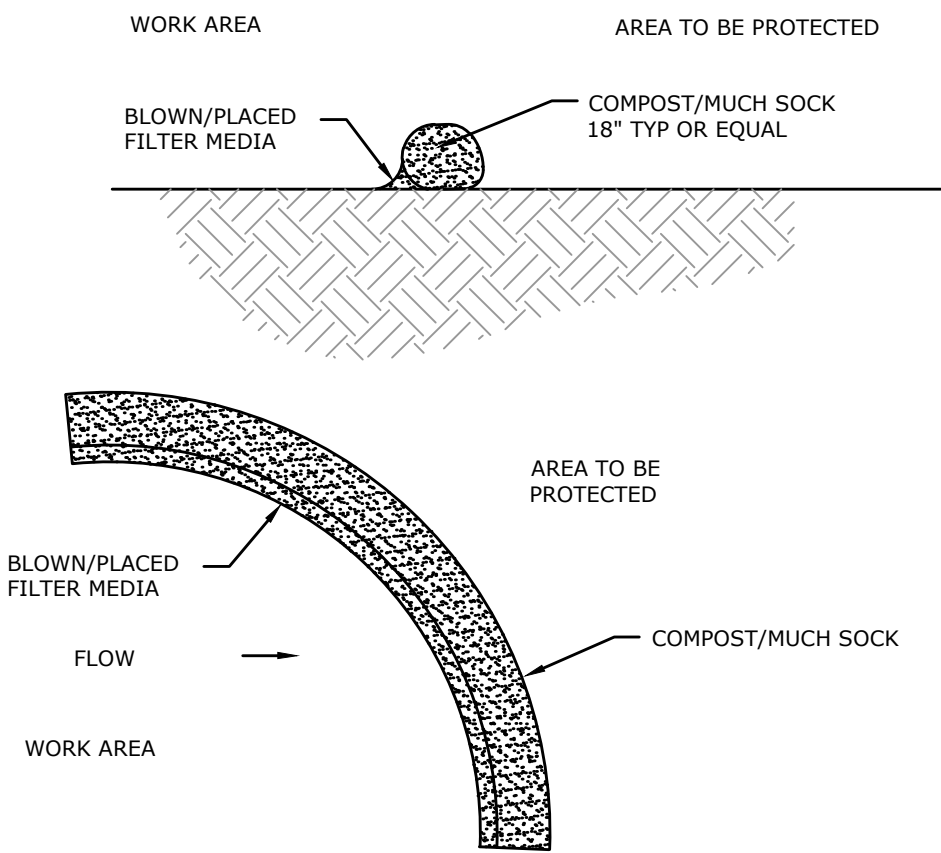

COMPOST/MULCH SOCK DETAIL

SCALE: NONE

SOIL EROSION AND SEDIMENT CONTROL DETAILS

SANITARY FORCE MAIN DESIGN  
400 MAIN STREET, EAST HARTFORD, CONNECTICUT  
PRATT & WHITNEY

SESC

SHEET NO. 4 NO. OF SHEETS 5

REV

DESCRIPTION OF REVISION

DATE

V:\FILES\PROJECTS\ACT\EAST HARTFORD\MAIN ST - 400\SANITARY FORCE MAIN DESIGN 68PP99.DWG (b6) SESC DETAILS Saved: 8/12/2019 8:46 PM Plotted: 8/12/2019 8:38 AM



